WEXLER RESIDENCE: 300 SOUTHPOINTE DRIVE, 4304 MIAMI BEACH, FL. 33139

DRAWING			
ARCHITEC		MECHA PLUMB	NICAL, ELECTRICAL & ING
T.1	TITLE SHEET.	M-1	MECHANICAL SCHEDULE
A.1	EXISTING CONDITIONS (POST DEMOLITION)	M-2	HVAC DUCT LOCATIONS
A.2	PROPOSED CONSTRUCTION FLOOR PLAN	M - 3	HVAC DUCT DETAILS
A.3	PROPOSED CONSTRUCTION DETAILS	E.1	ELECTRICAL NOTES
A.4	PROPOSED CONSTRUCTION DETAILS	E.2	ELECTRICAL POWER
A.5	MASTER BATHROOM PLAN AND ELEVATIONS	E.4	ELECTRICAL PANEL & RISERS
A.6	BATHROOM 1, PLAN AND ELEVATIONS	P.1	PLUMBING SCHEDULE
A.7	BATHROOM 2 PLAN AND ELEVATIONS	P.2	EXISTING PLUMBING PLAN
A.8	KITCHEN, PLAN AND ELEVATIONS	P.3	PLUMBING SANITARY & DOMESTIC WATER FLOOR PLAN
E.1	REFLECTED CEILING PLAN		
FP.1	FIRE PROTECTION DETAILS		
FP.2	FIRE SPRINKLER LOCATIONS		
LS.1	LIFE SAFETY NOTES		

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WEXLER RESIDENCE 300 SOUTHPOINTE DR. 4304

MIAMI BEACH, FL. 33139

NOTES

No.	Date	Description
1	1.17.2024	FIRST SUBMISSION(QUOTES)

TITLE


TITLE SHEET

DATE: 1.17.2024
PROJECT No: 21007
DRAWN BY: JRS
CHECKED BY: ARE
DWG No:

T-1

eg tion 016

SPACE FOR NYC-BSCAN STICK

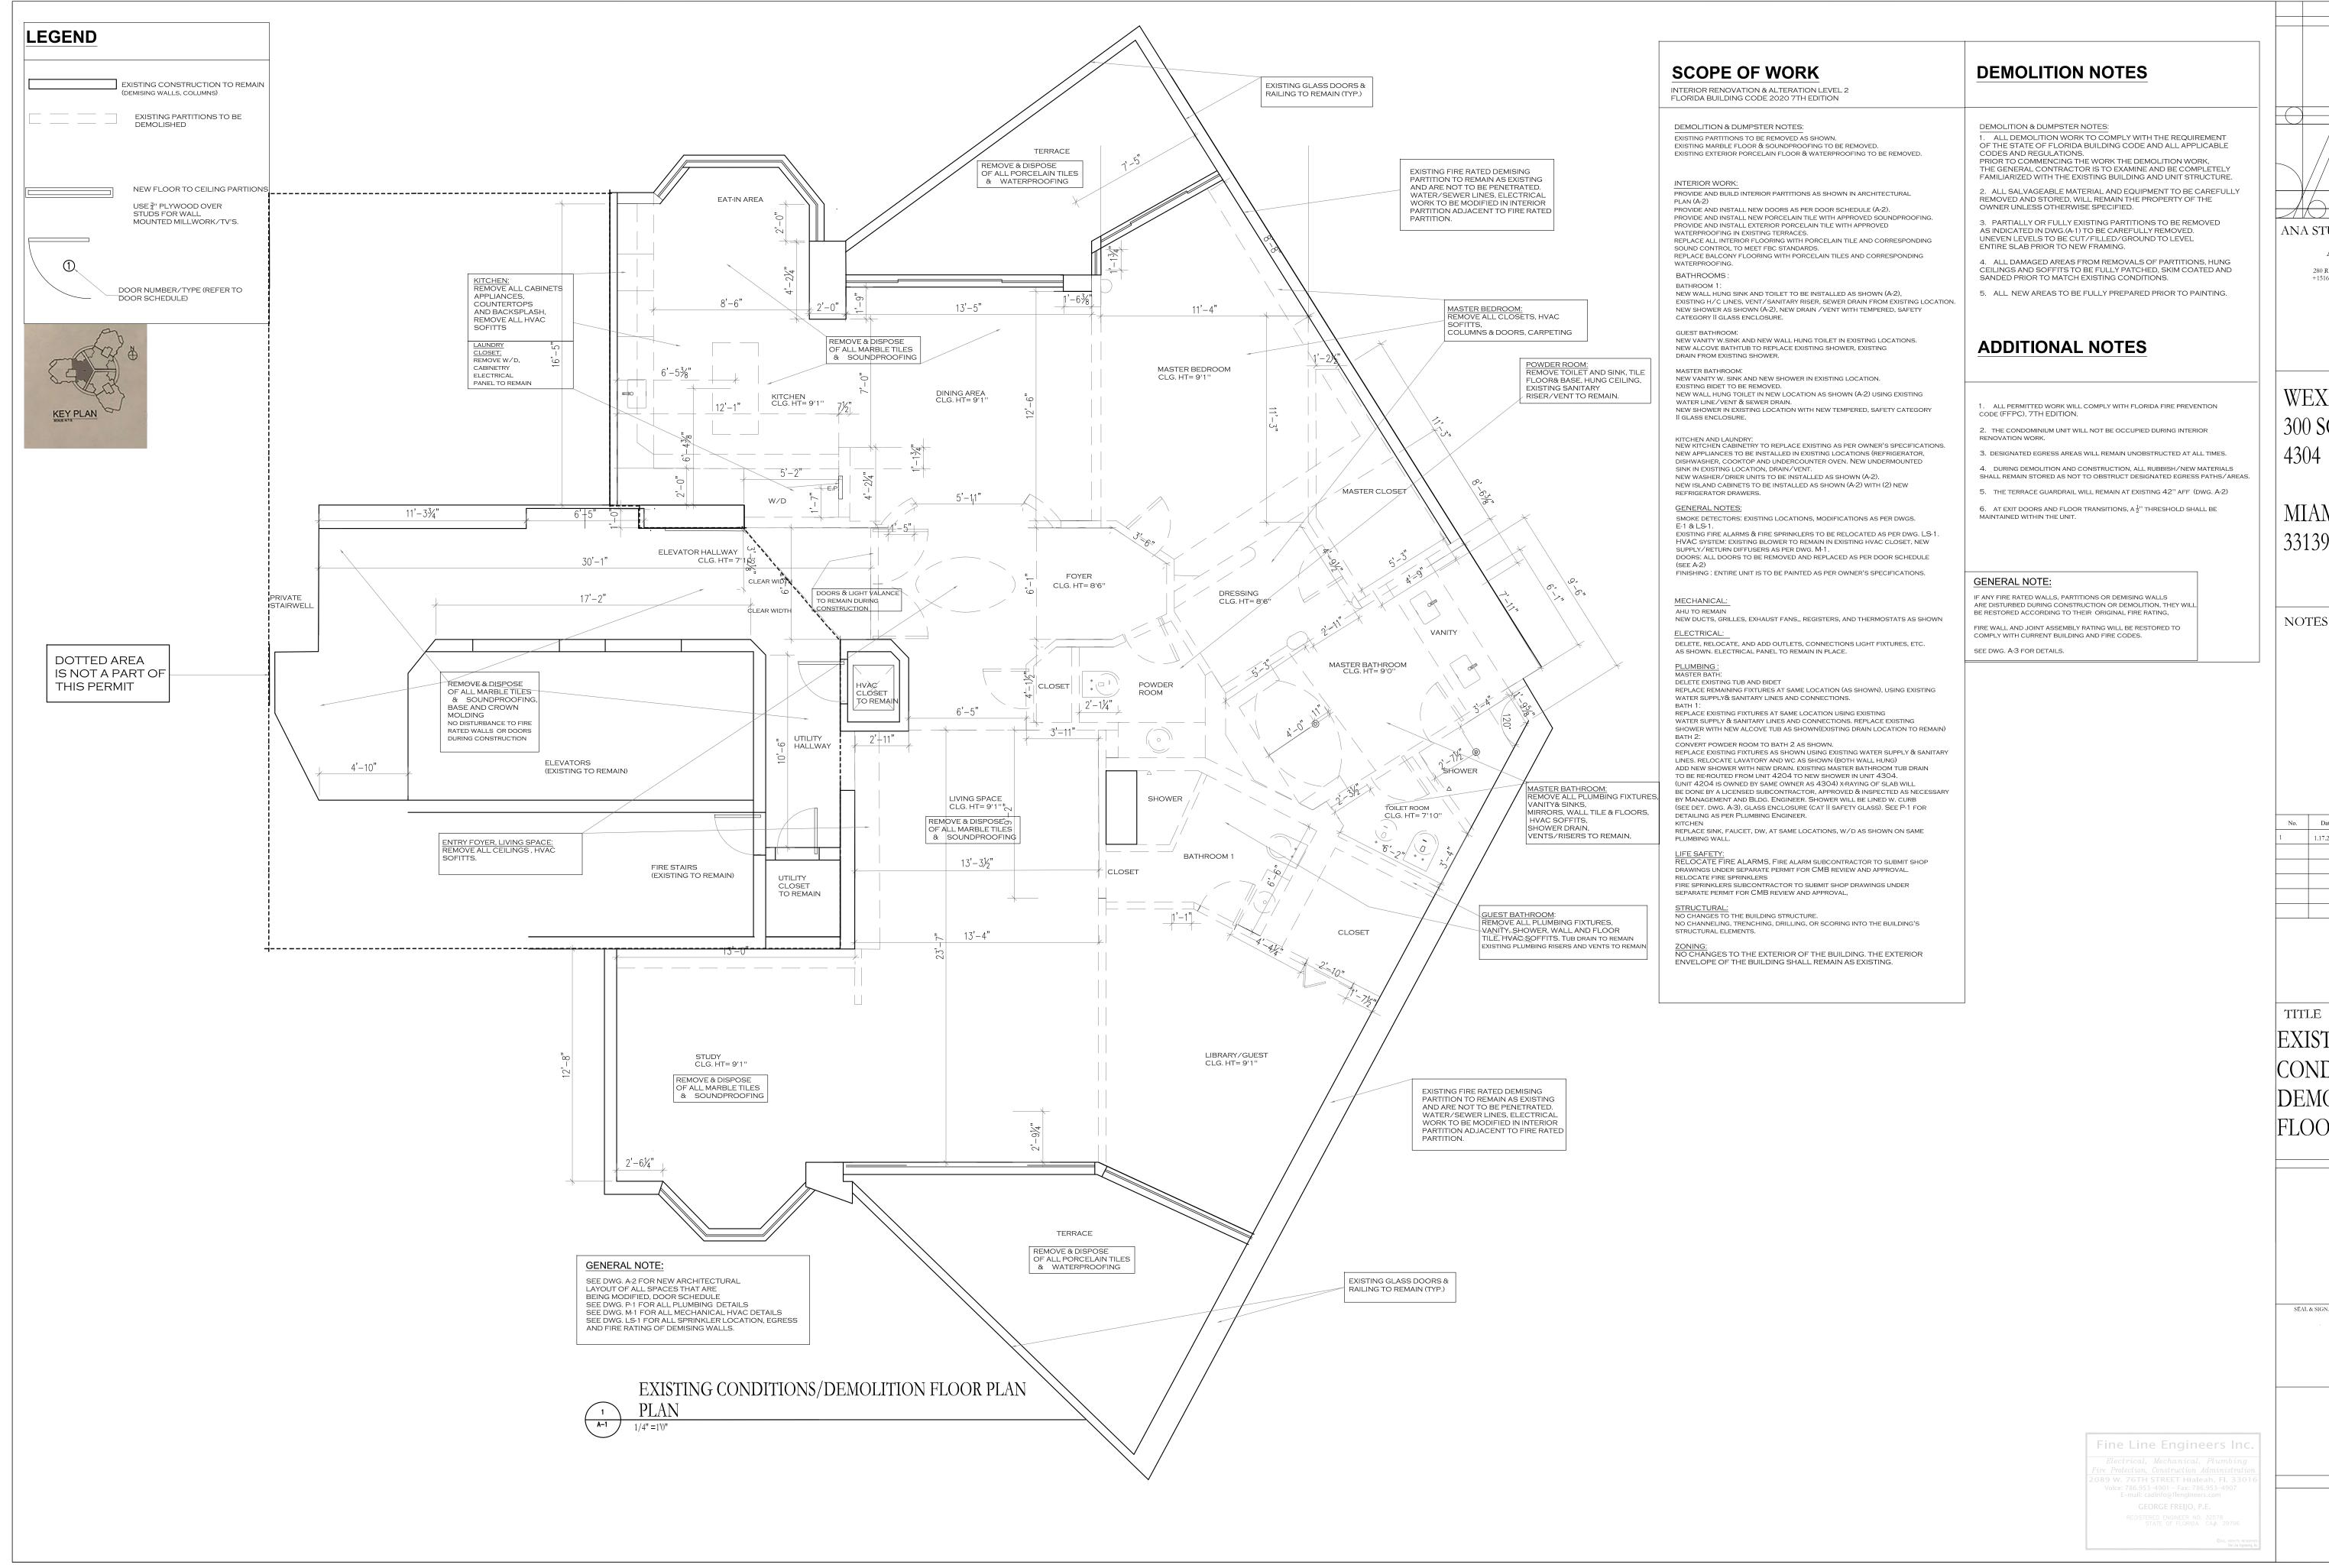

ANA STUDIO ARCHITECTURE, PC ANA R.ESKREIS,RA

> 280 RIVERSIDE DRIVE (8H), NEW YORK, N.Y.10025 1516.641.5416 +33 (6) 43 86 24 55 ANASTUDIO2013@GMAIL.COM www.FRENCHDIBS.com

WEXLER RESIDENCE 300 SOUTHPOINTE DR.

MIAMI BEACH, FL.


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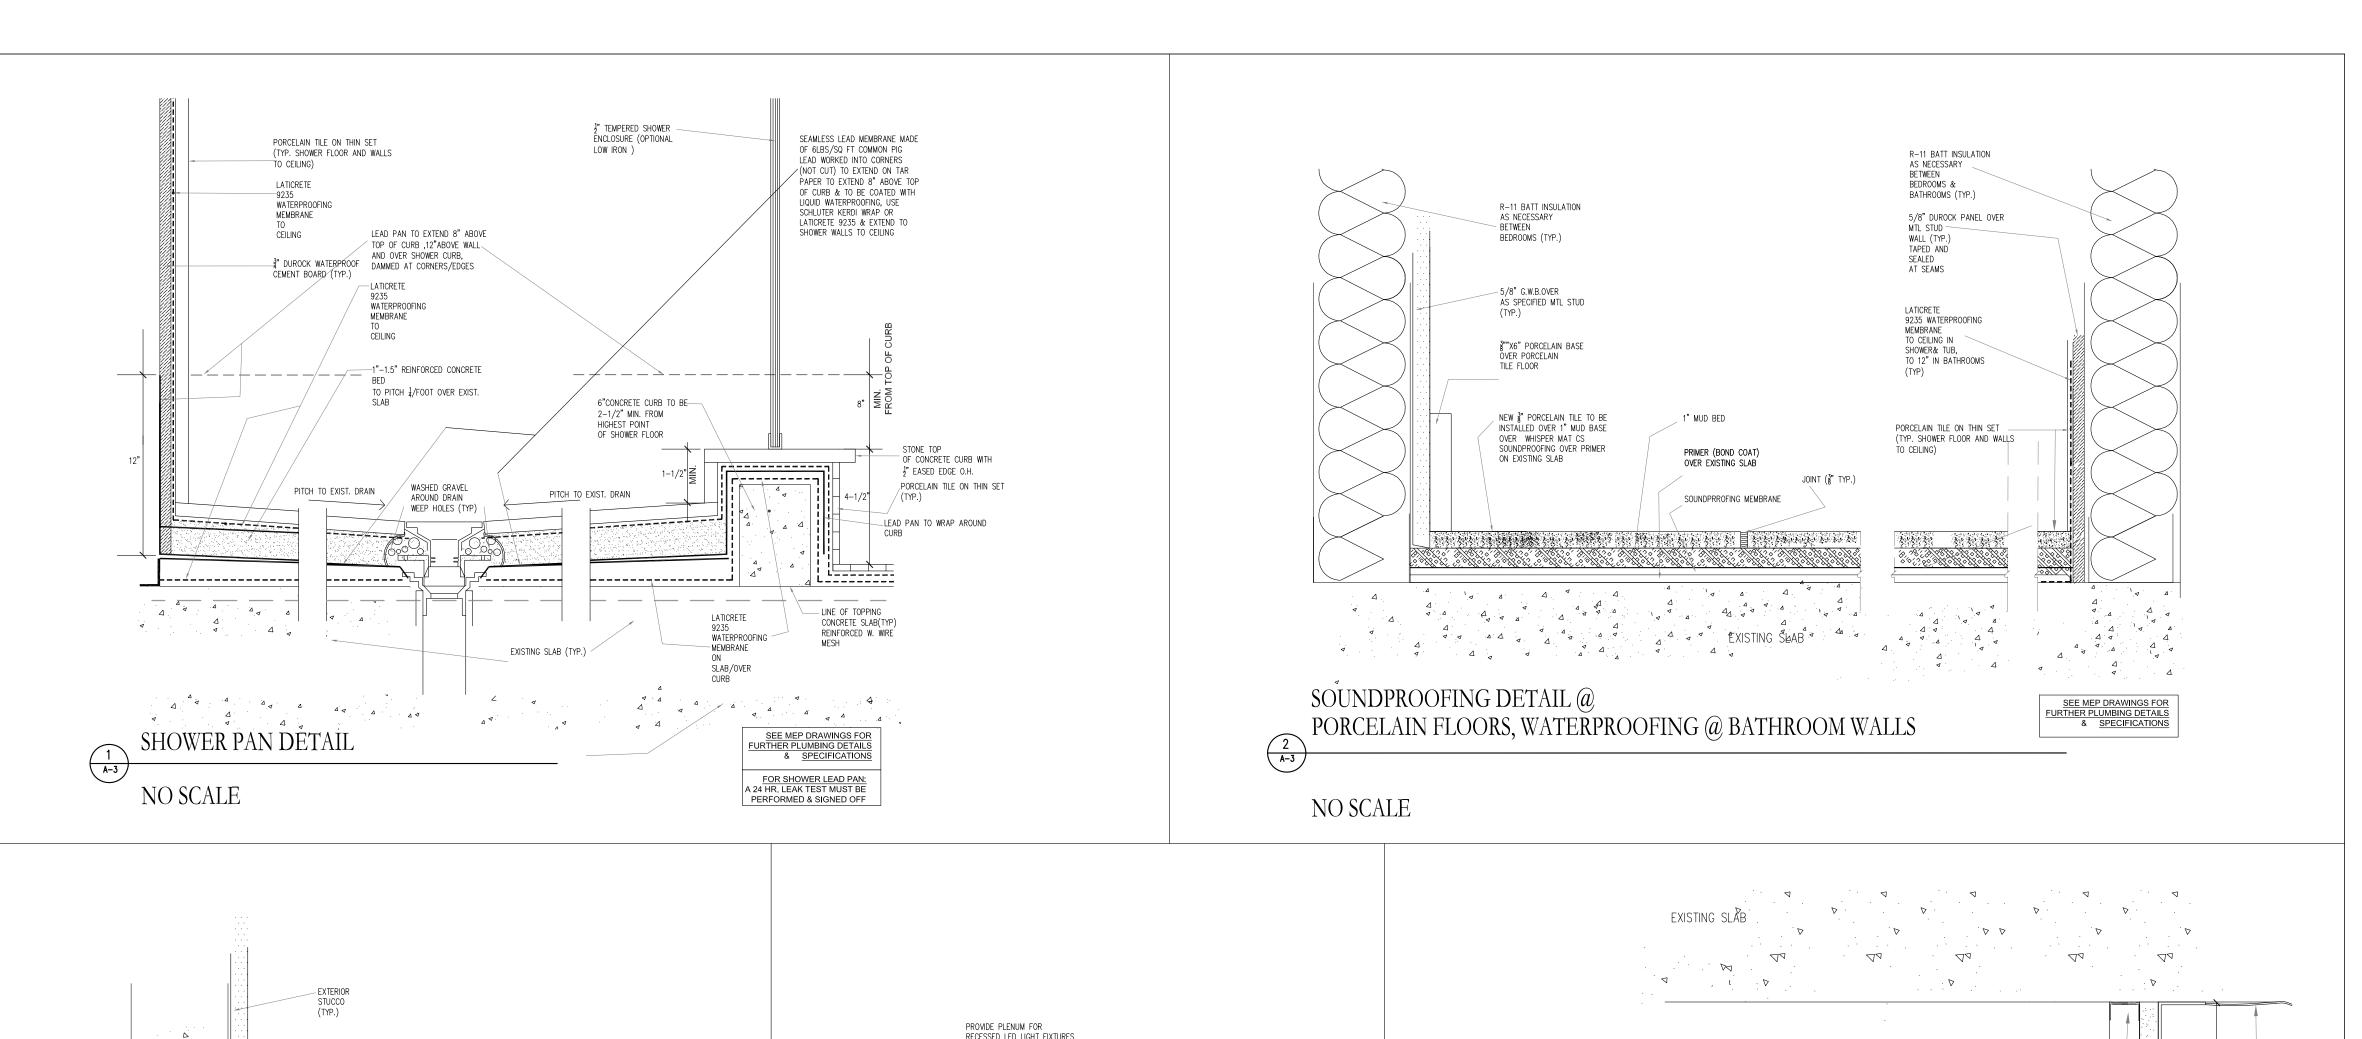
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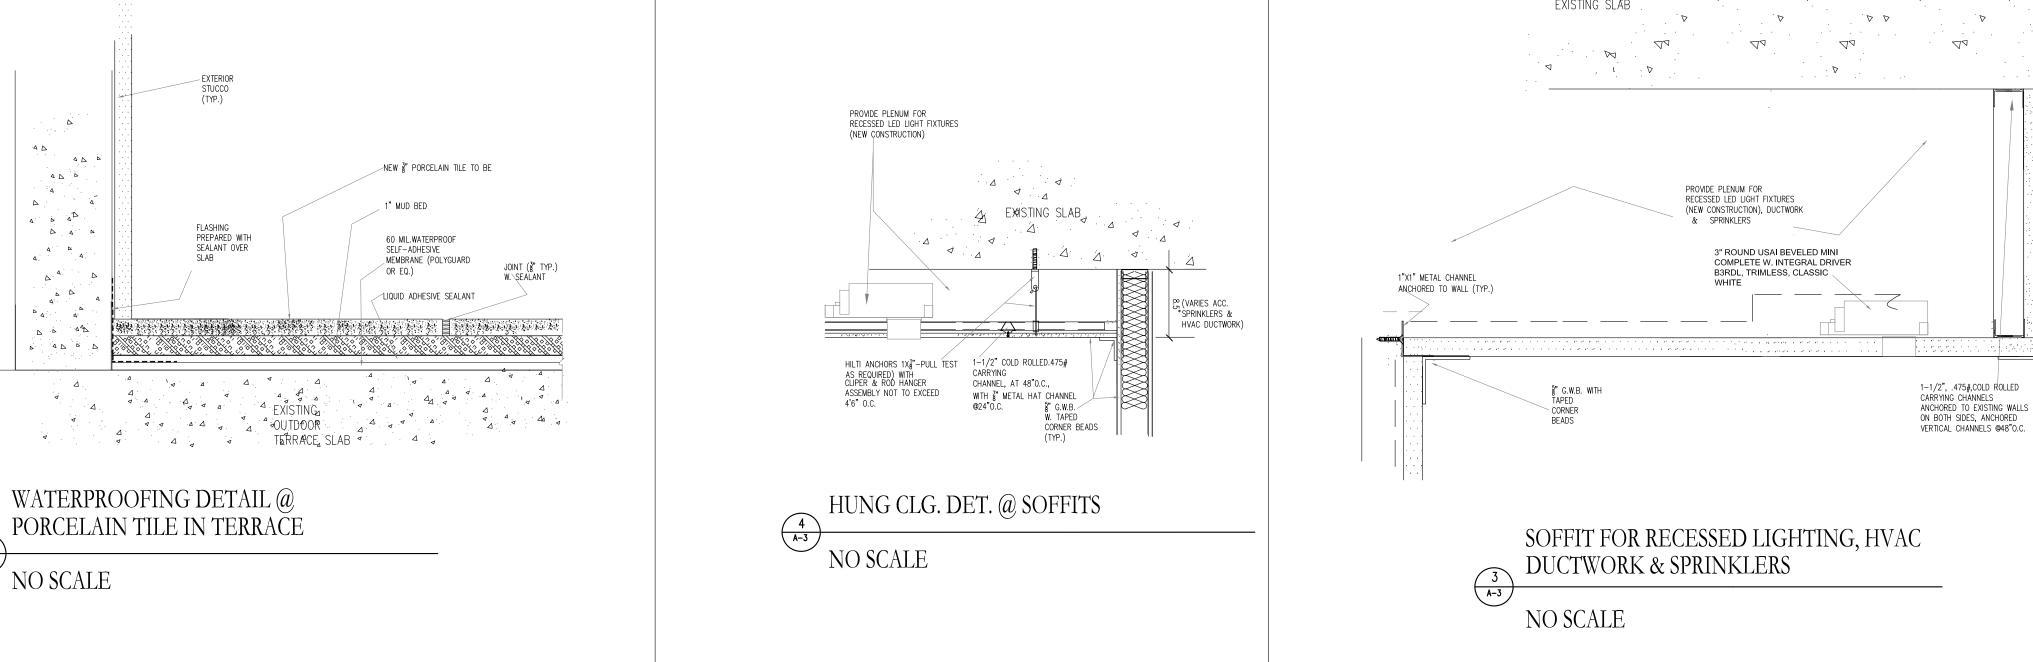
EXISTING CONDITIONS/ DEMOLITION FLOOR PLAN

> SEAL & SIGNATURE PROJECT No: 21007 DRAWN BY: JRS CHECKED BY: ARE

PAGE 1 OF 12





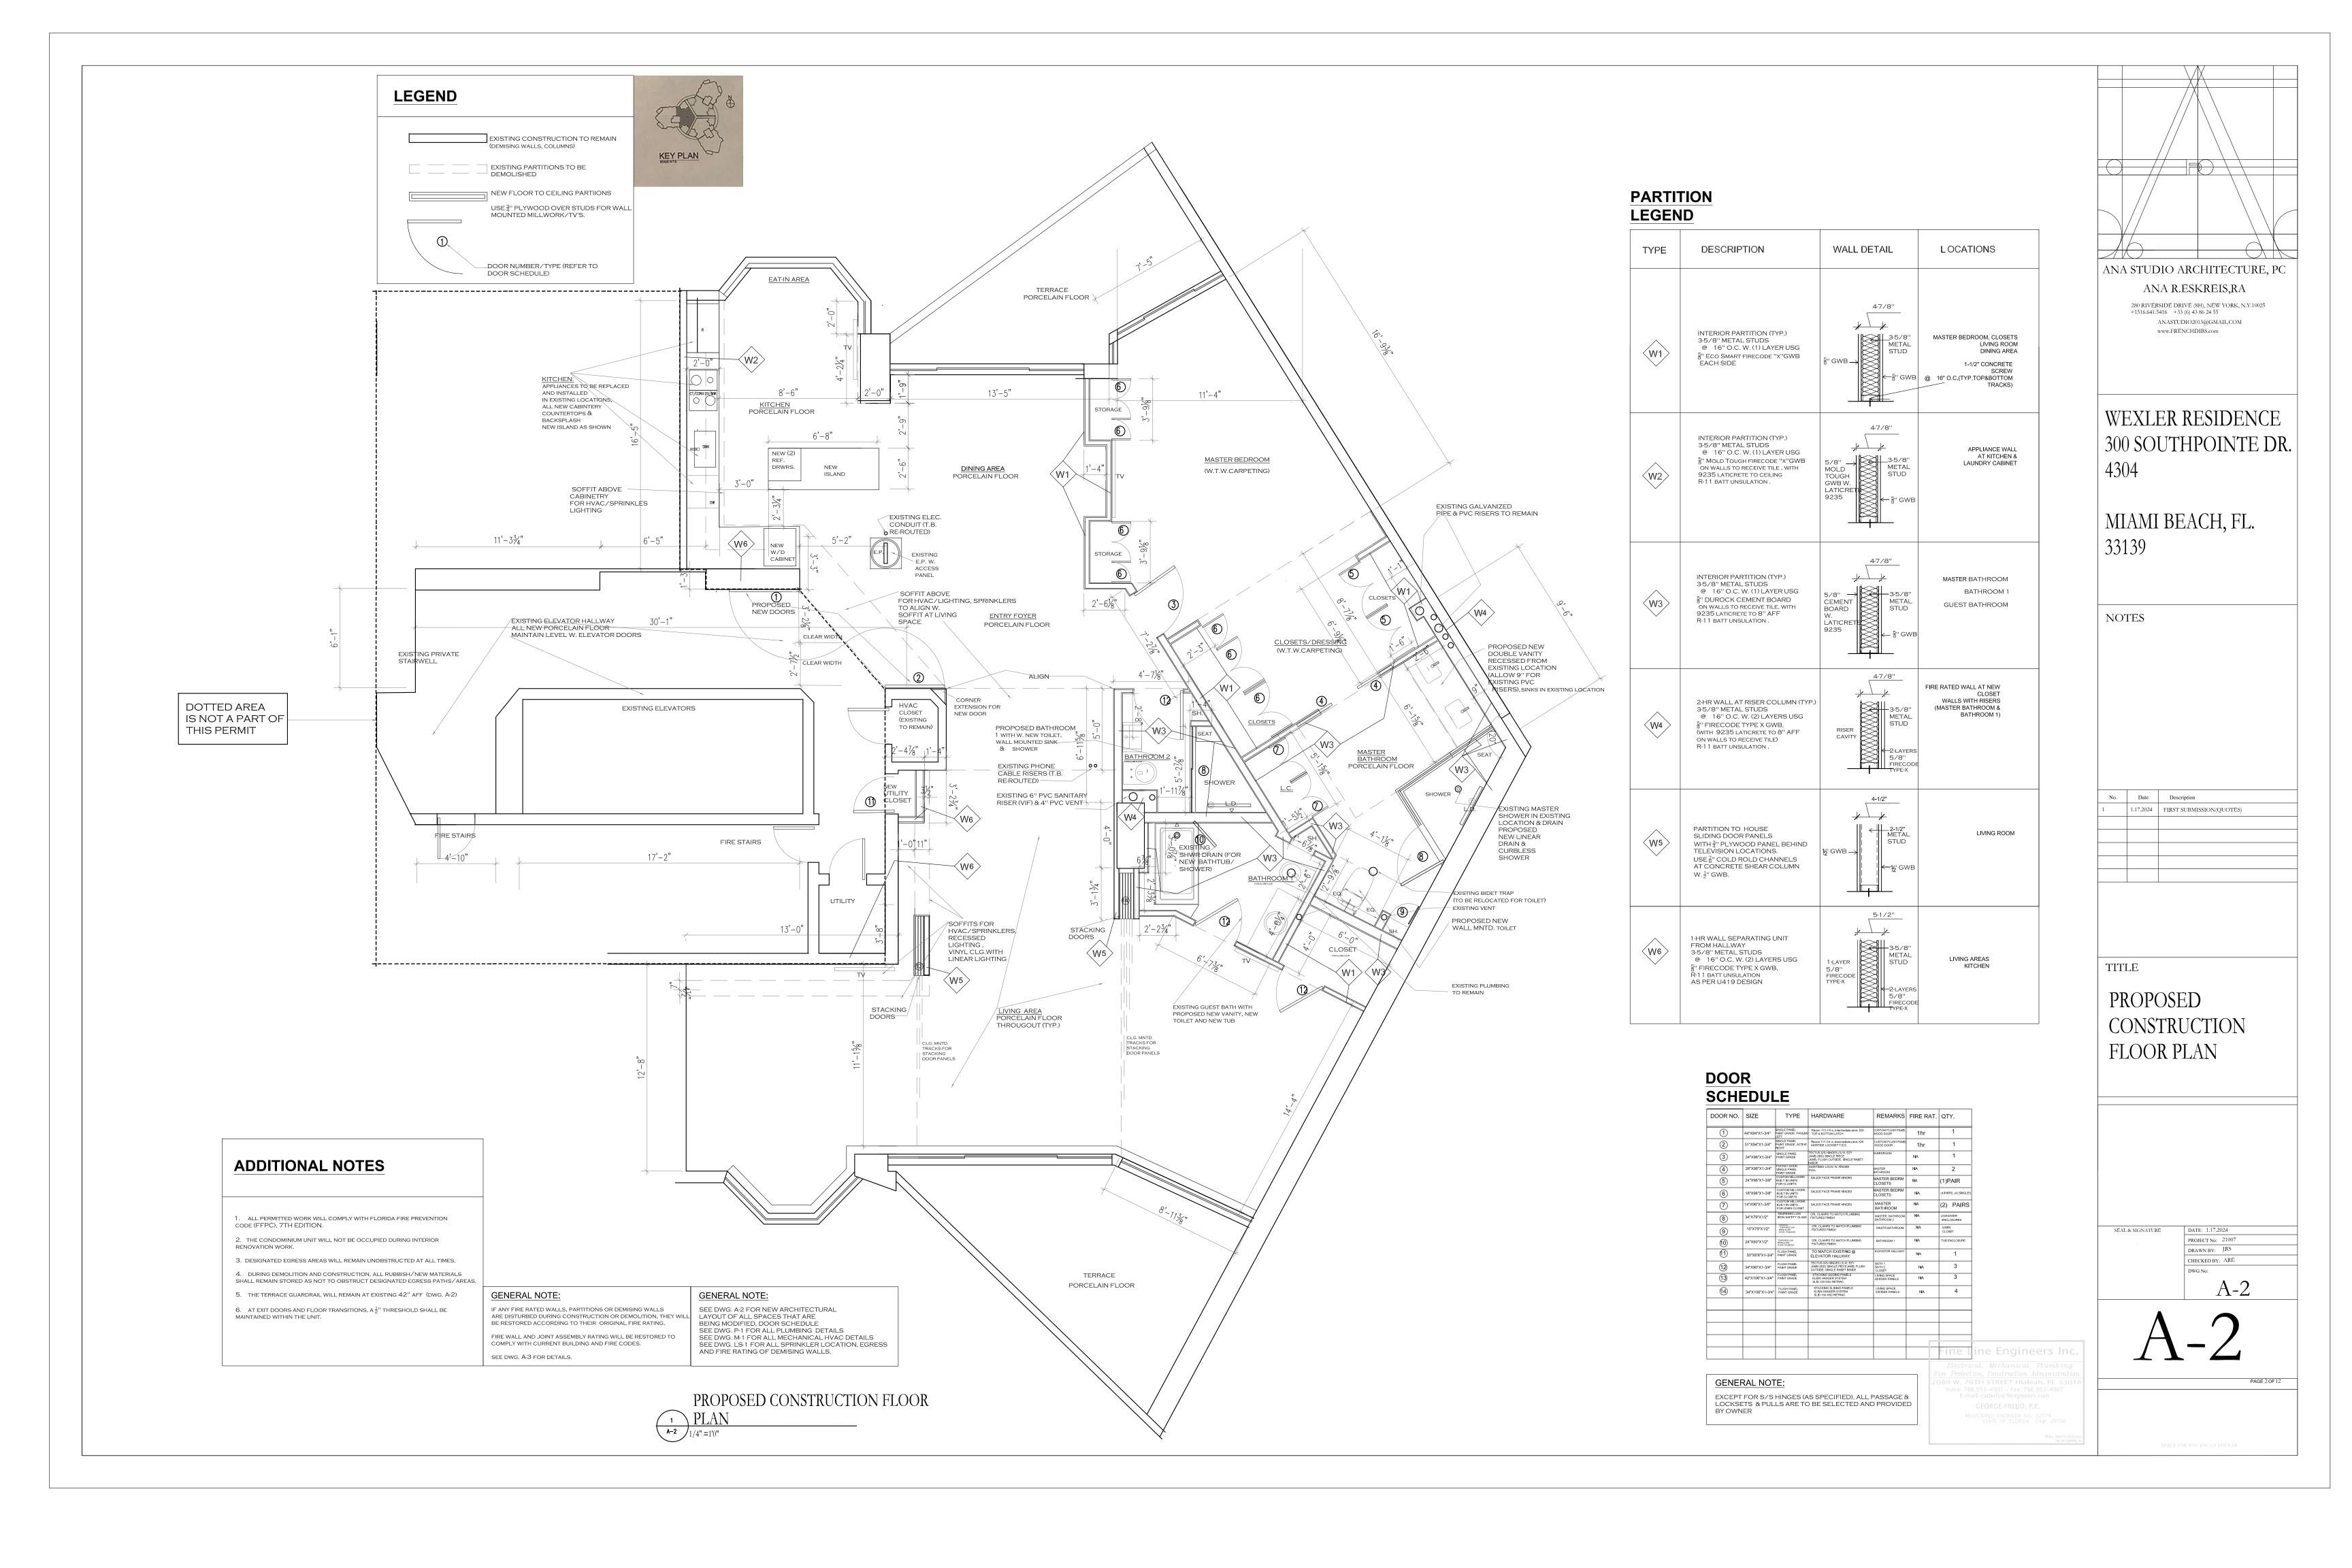


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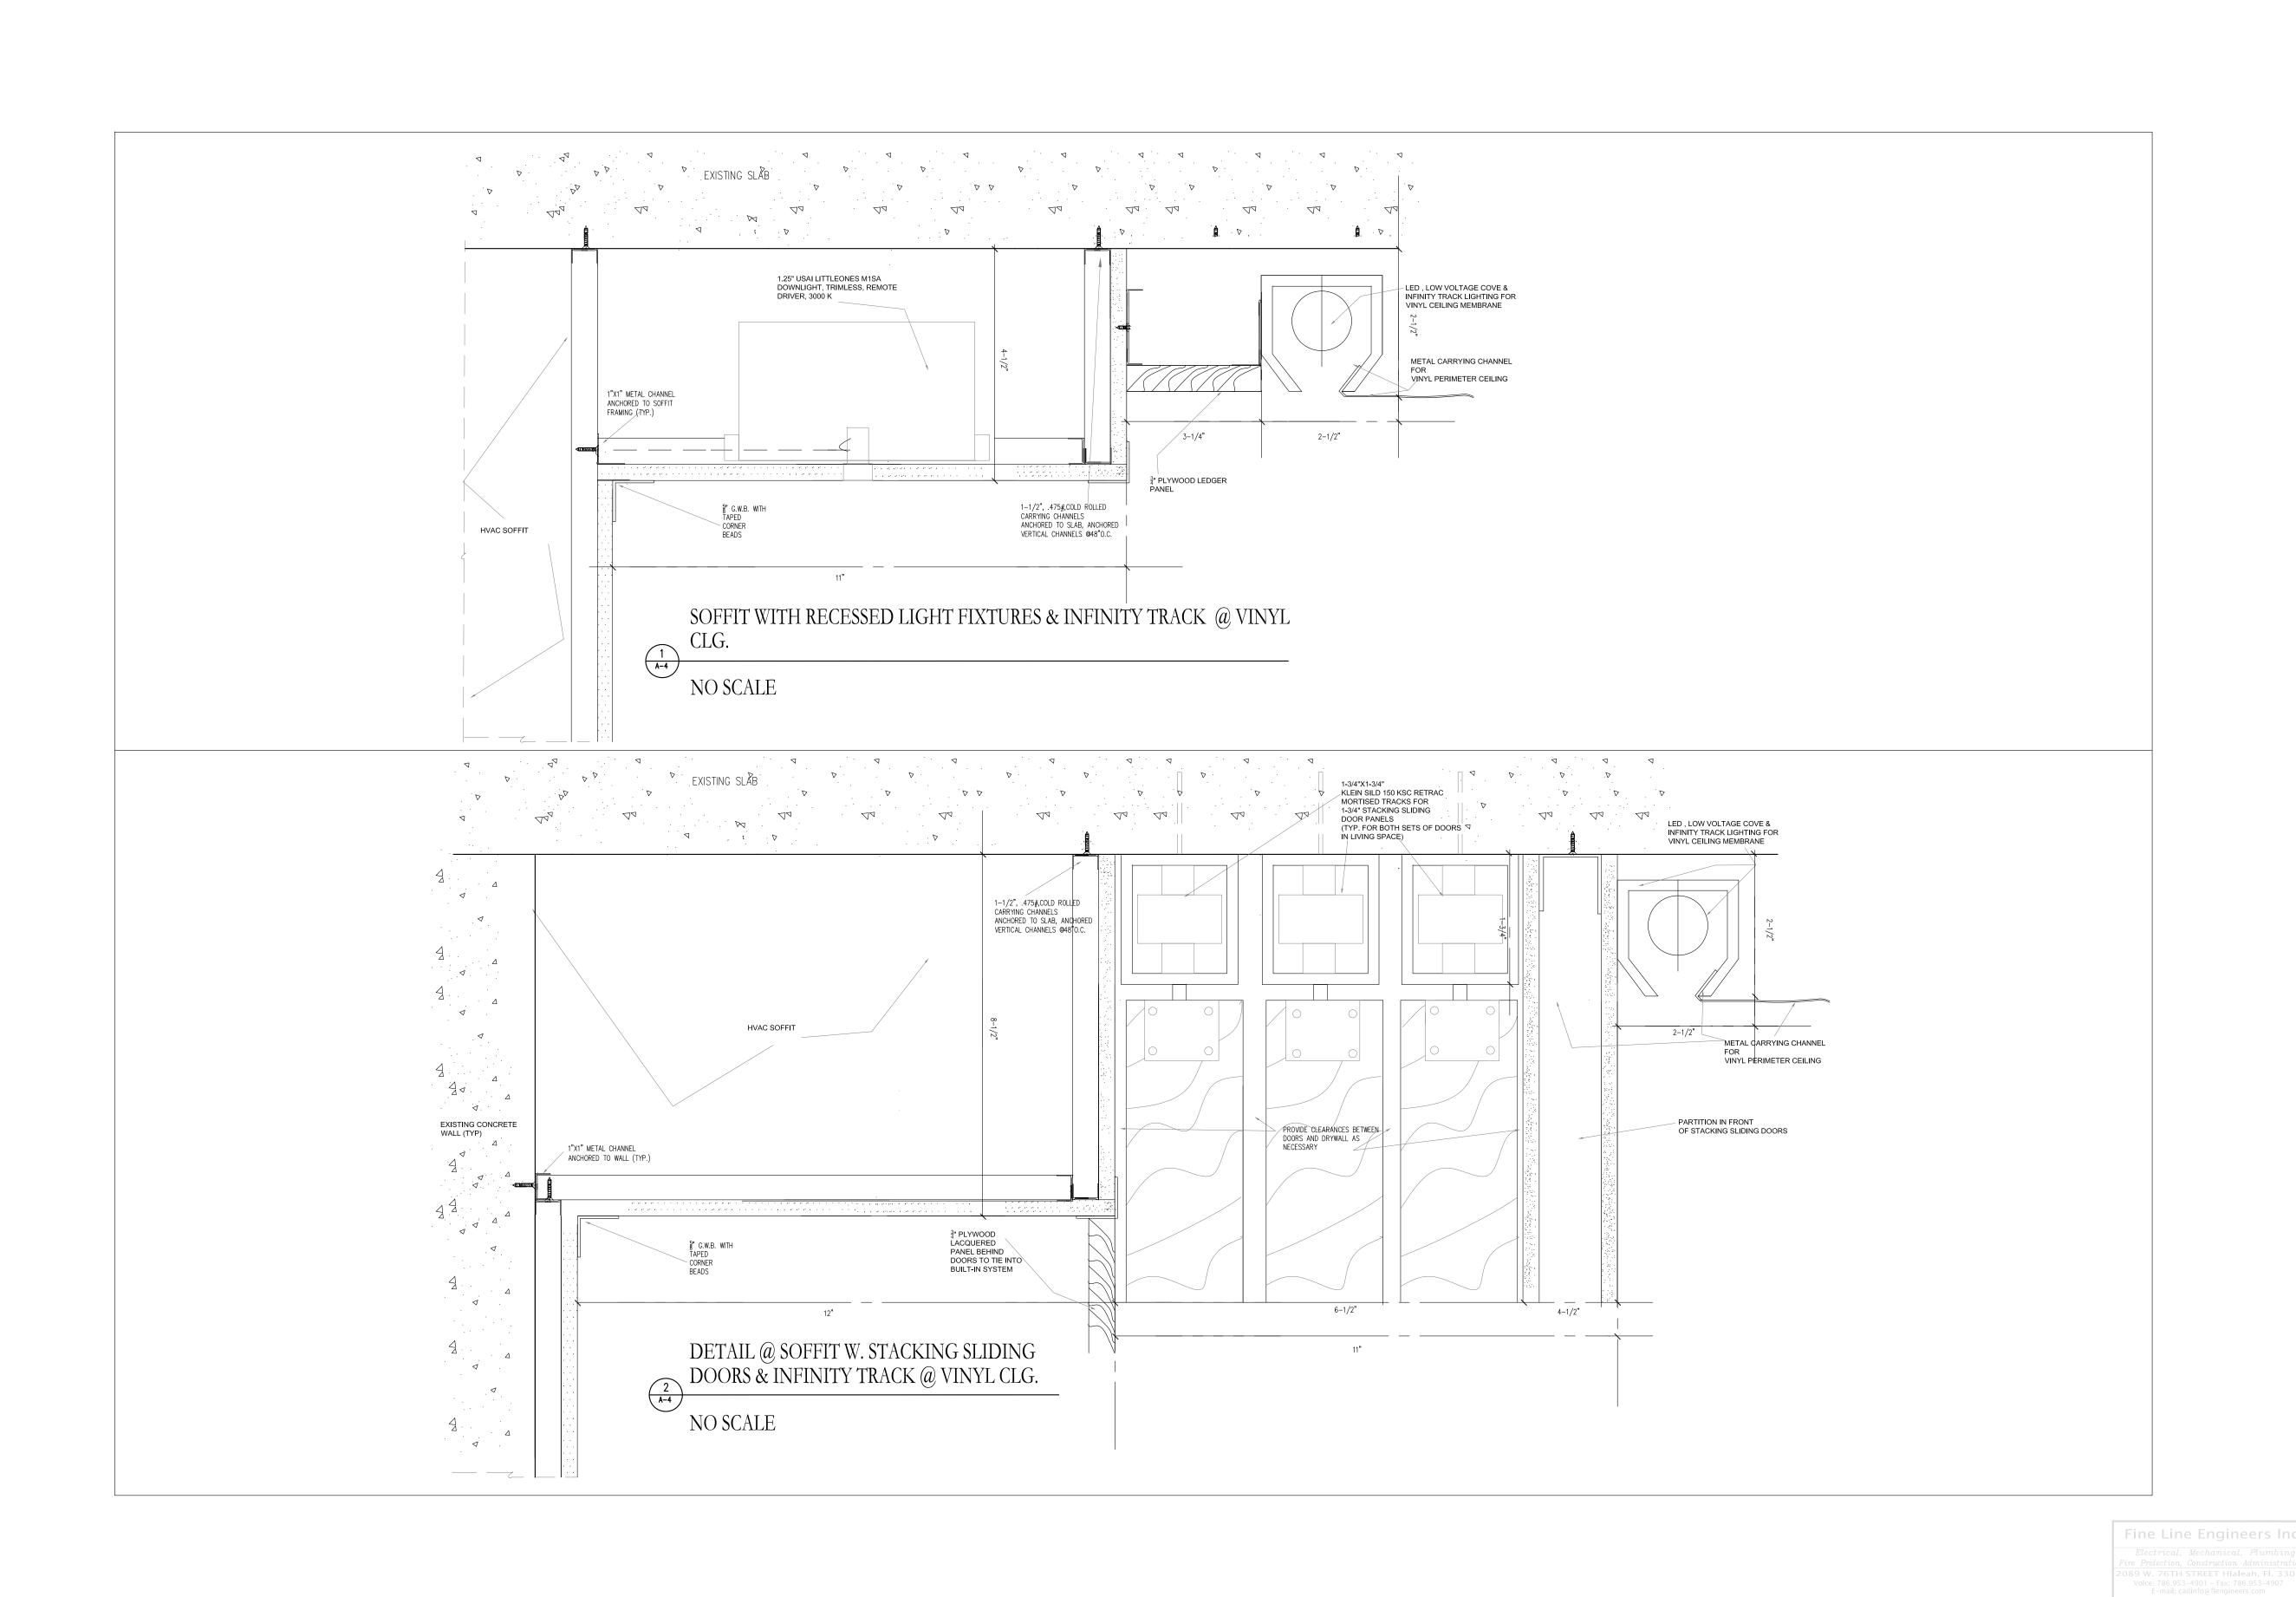
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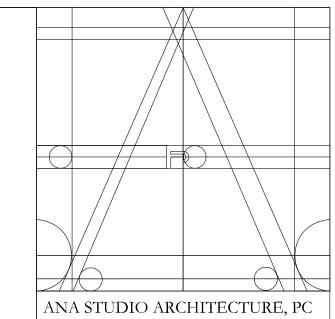


PAGE 30F12

SKIM COATED EXISTING

CONCRETE CEILING

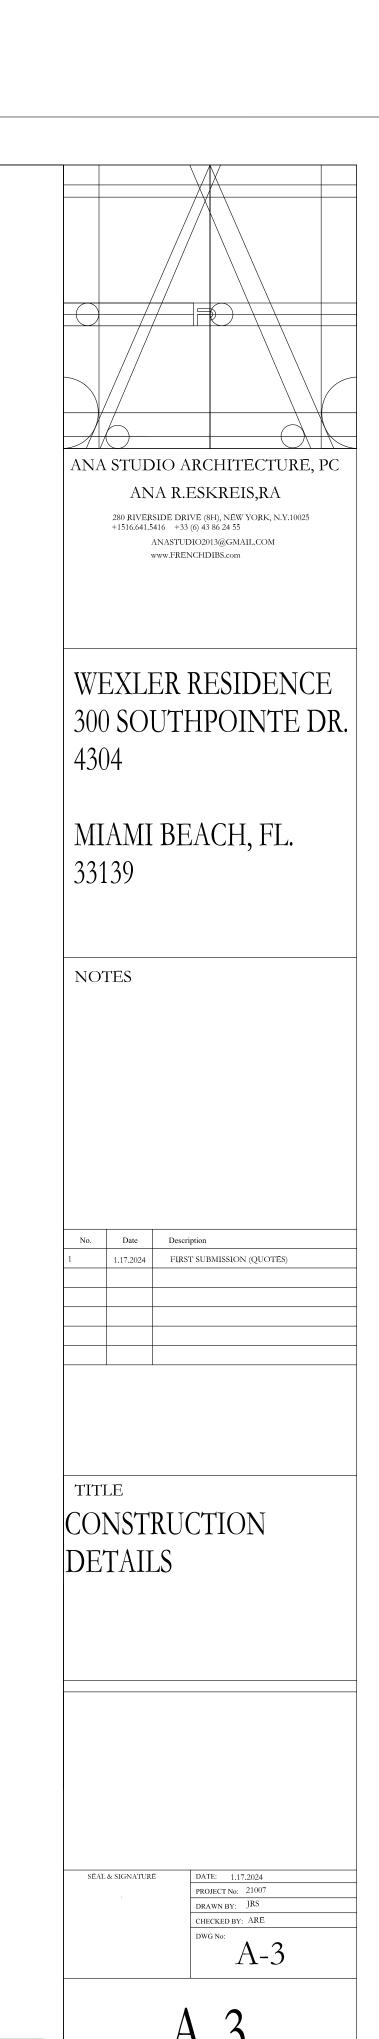



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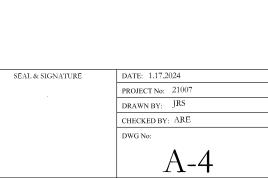
MIAMI BEACH, FL. 33139

NOTES

No.	Date	Description
1	1.17.2024	FIRST SUBMISSION(QUOTES)

TITLE


CONSTRUCTION DETAILS




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PAGE 4 OF 12

SPACE FOR NYC-BSCAN STICKER



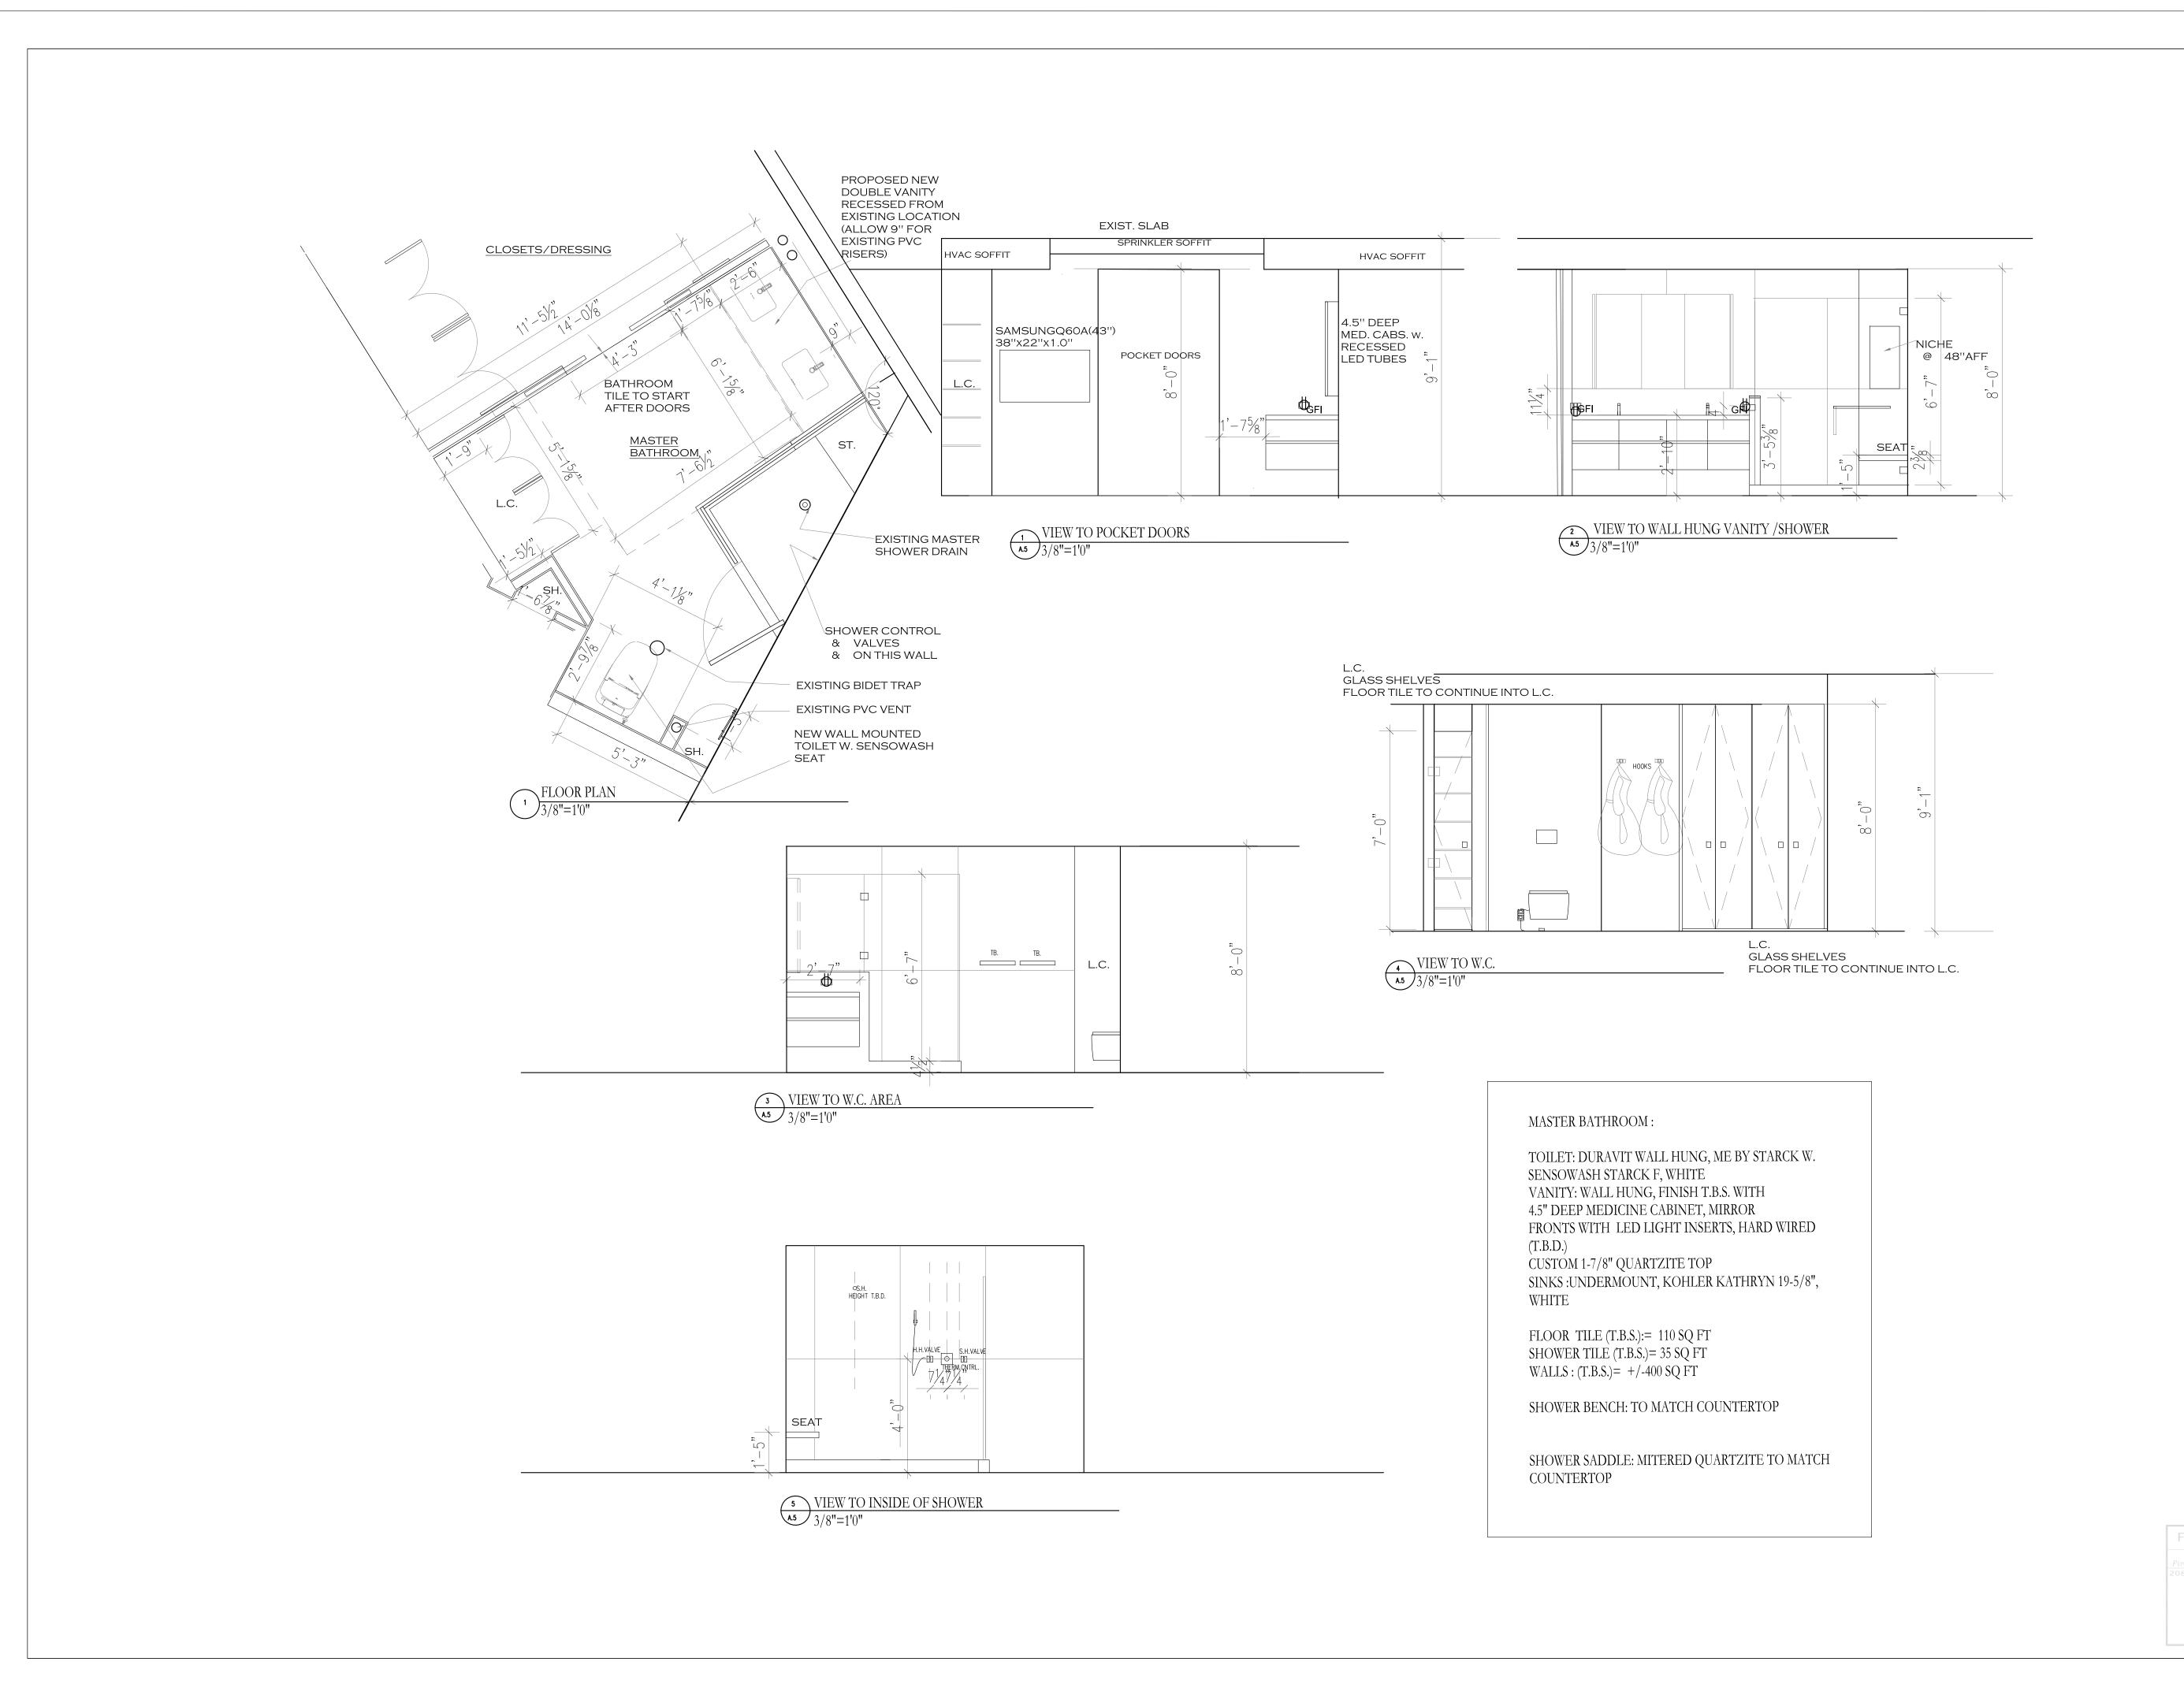
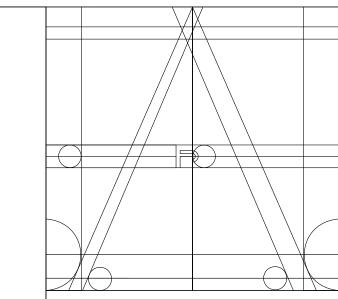
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NOTES

No. Date Description

1 1.17.2024 FIRST SUBMISSION(QUOTES)

TITLE

MASTER BATHROOM

SEAL & SIGNATURE

DATE: 1.17.2024

PROJECT No: 21007

DRAWN BY: JRS

CHECKED BY: ARE

DWG No:

A-5

A-5


SPACE FOR NYC-BSCAN STICKER


PAGE 5 OF 12

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Voice: 786.953-4901 - Fax: 786.953-4907
E-mail: cadinfo@flengineers.com

GEORGE FREIJO, P.E.

REGISTERED ENGINEER NO. 32578

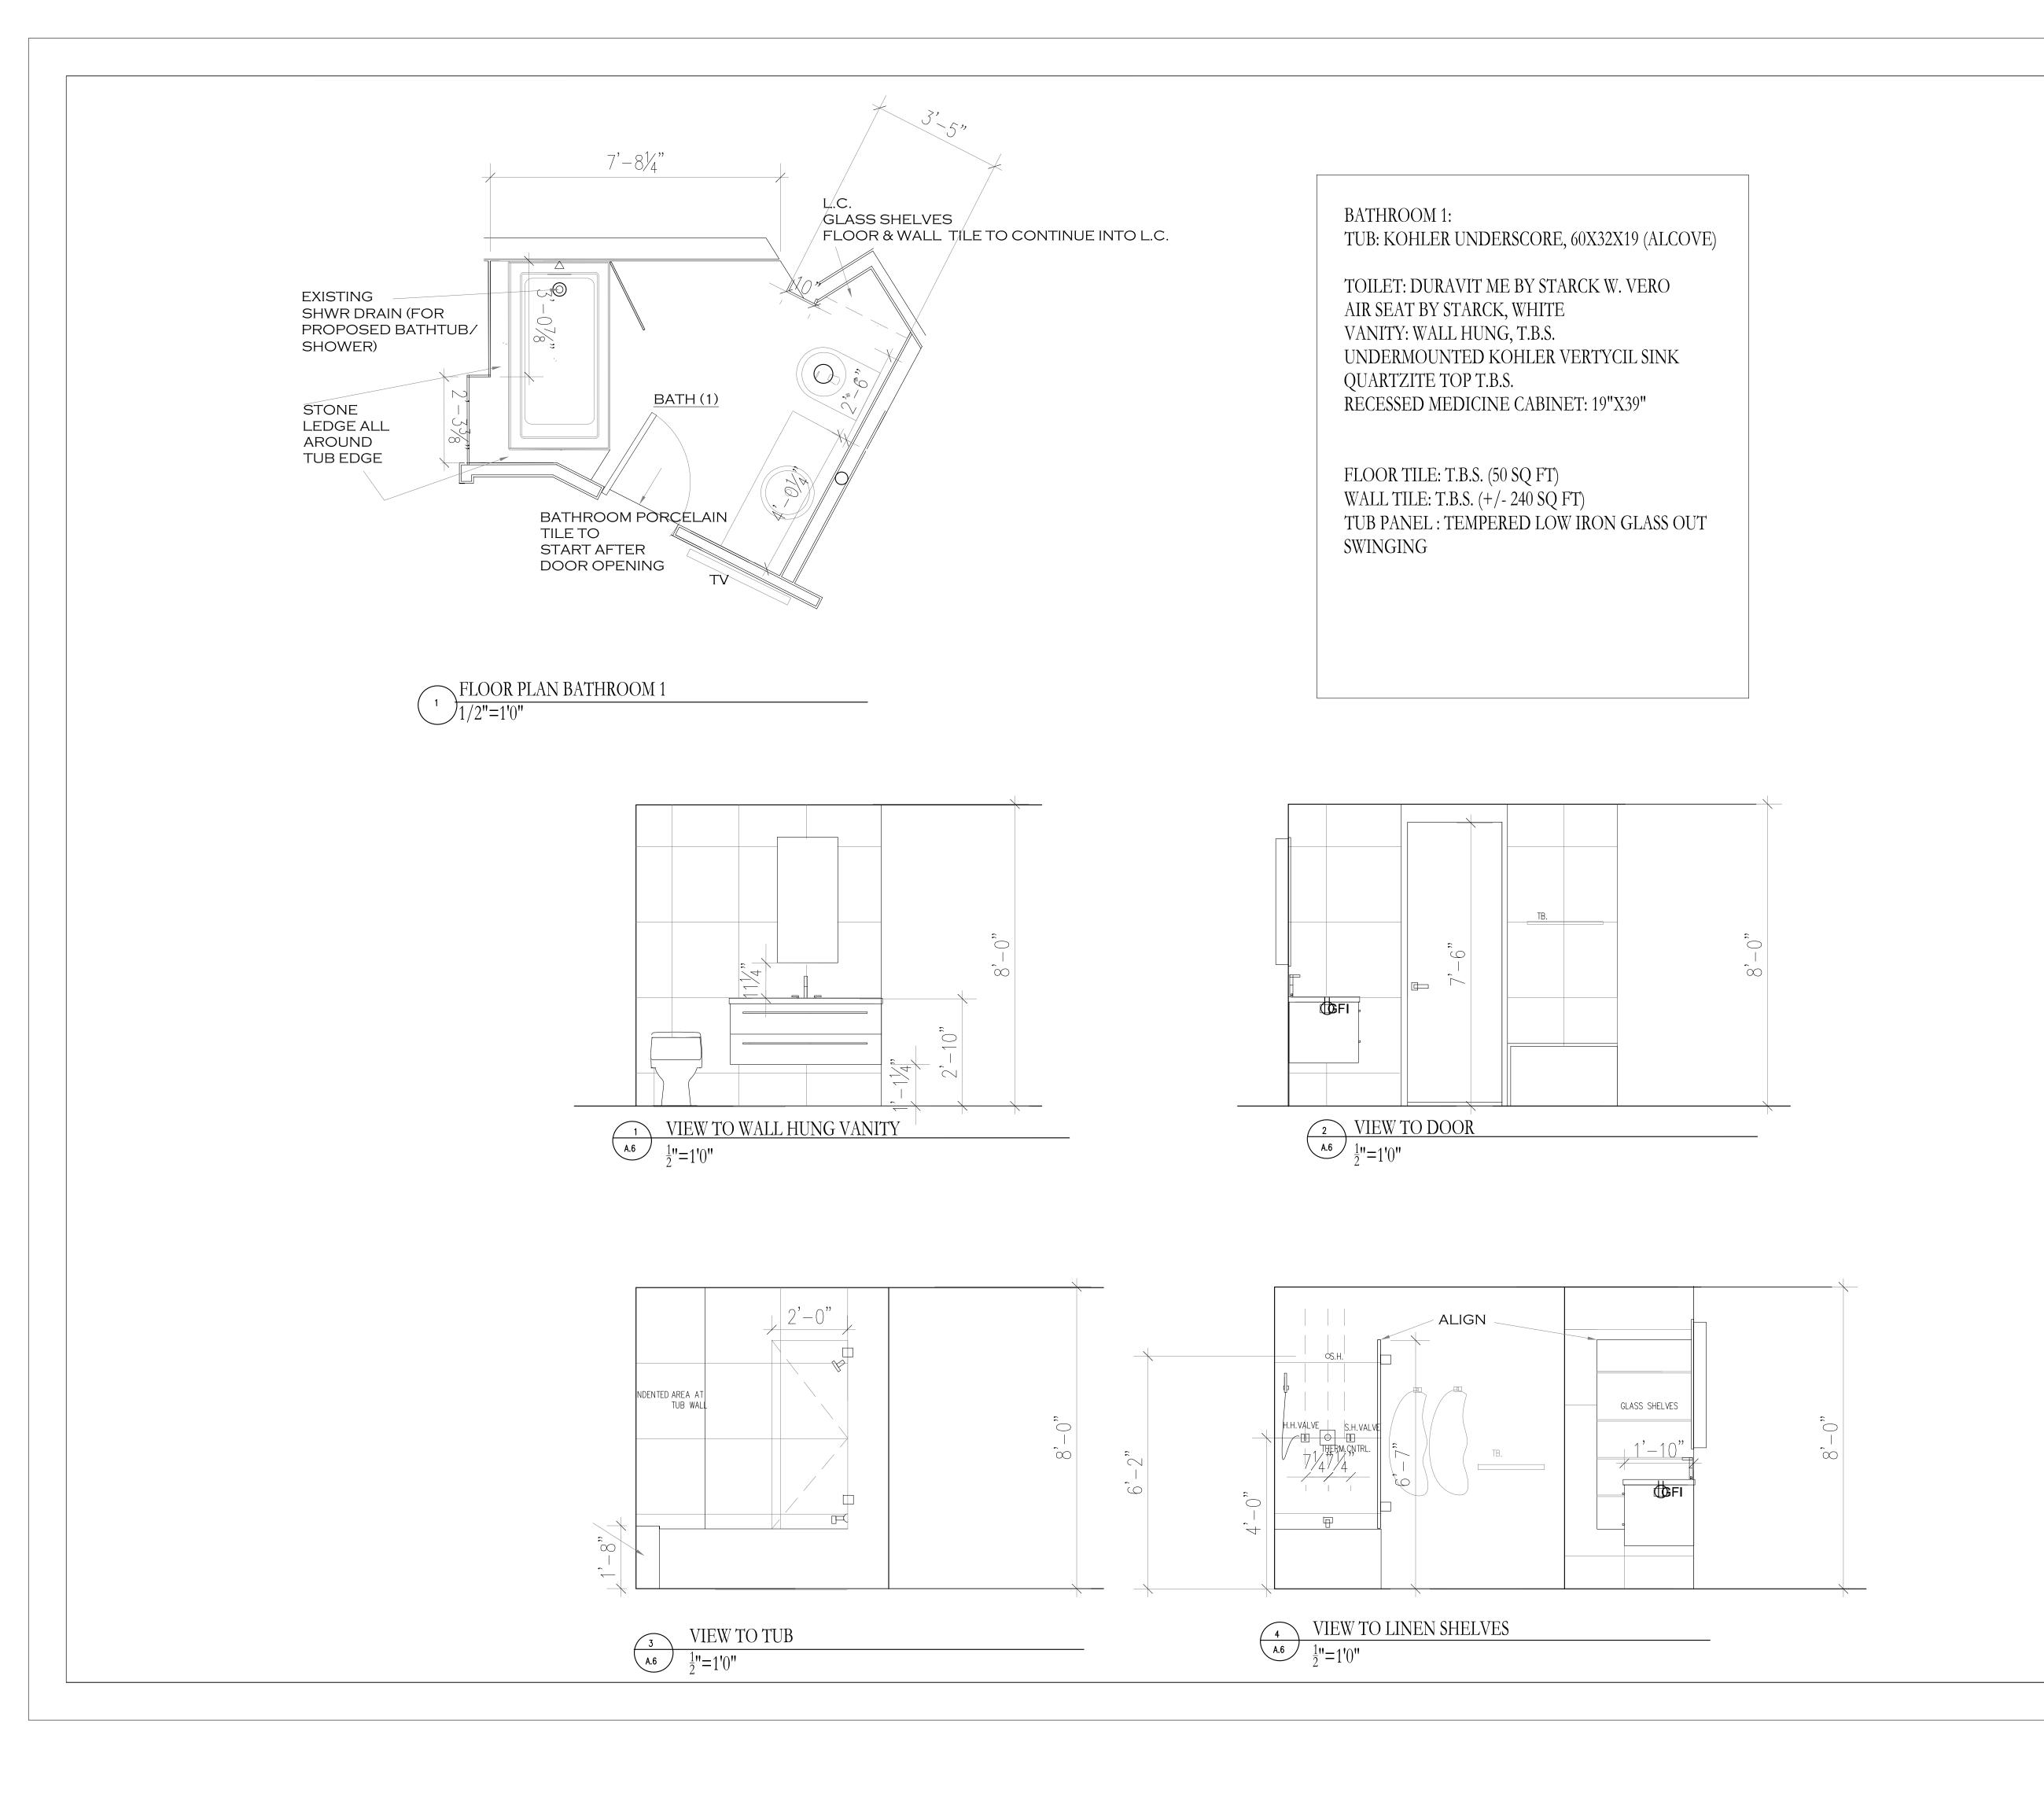

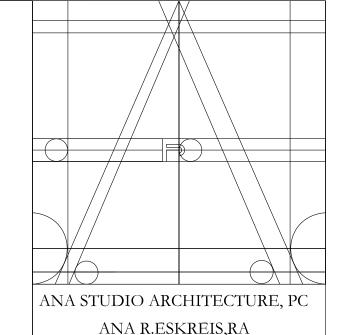

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MIAMI BEACH, FL. 33139

NOTES

No.	Date	Description
1	1.17.2024	FIRST SUBMISSION(QUOTES)

TITLE

BATHROOM 1: FLOOR PLANS ELEVATIONS

DATE: 1.17.2024

PROJECT No: 21007

DRAWN BY: JRS


CHECKED BY: ARE


DWG No:


A-6


A-6

SPACE FOR NYC-BSCAN STICKER

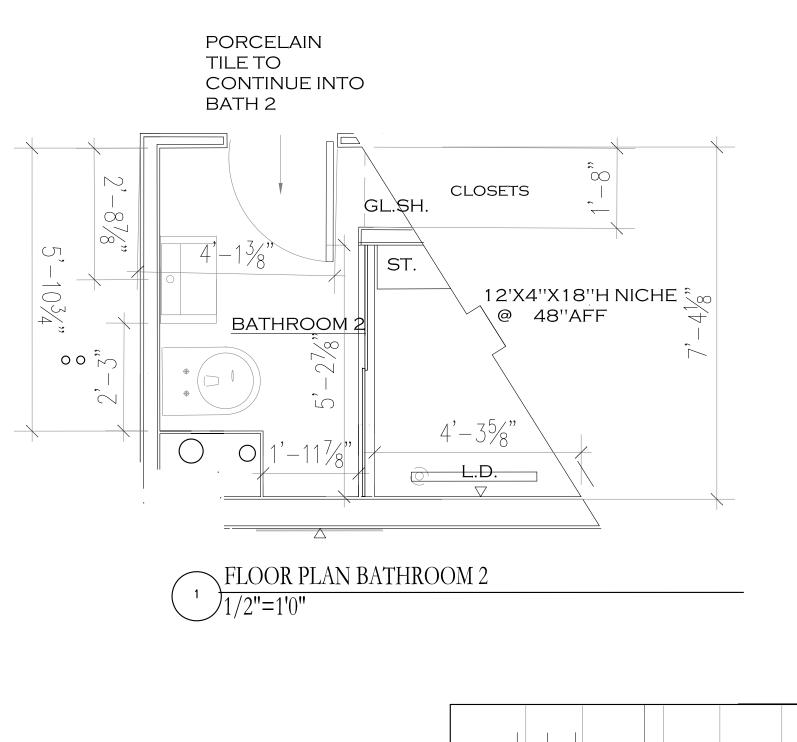

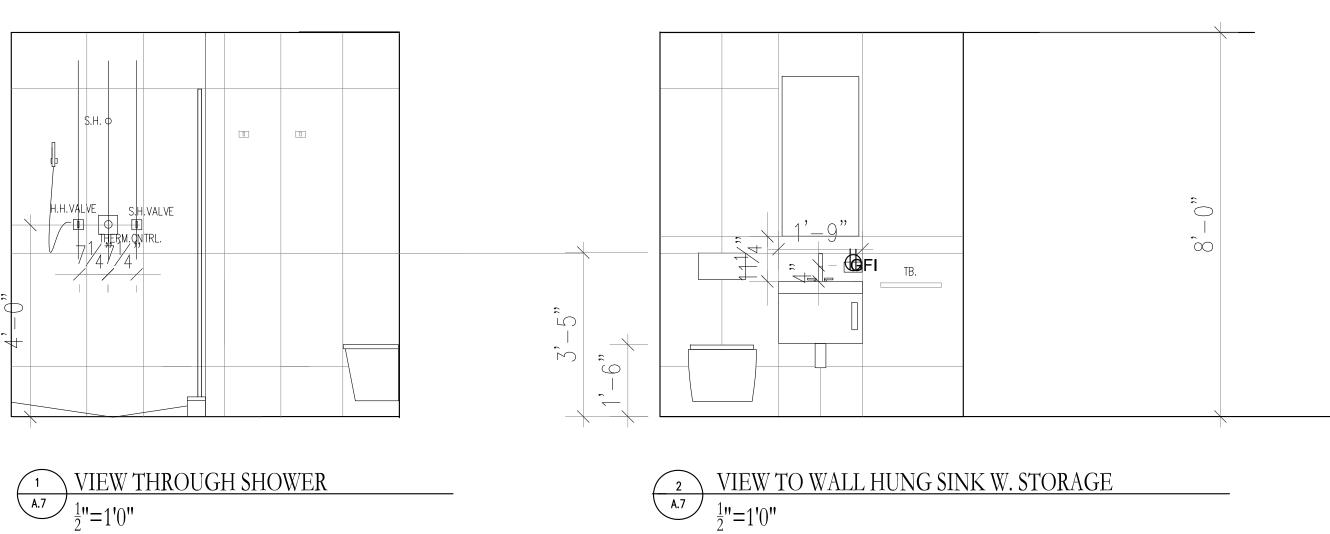

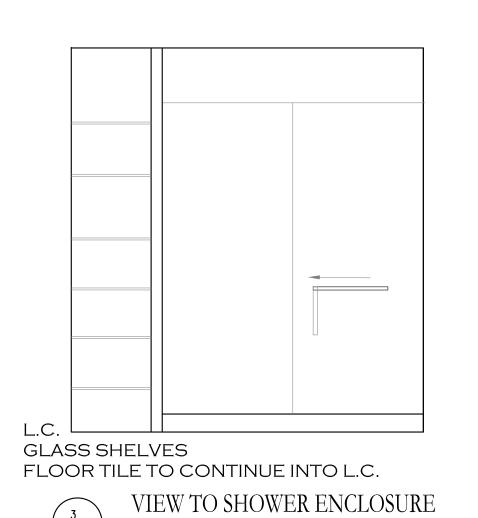

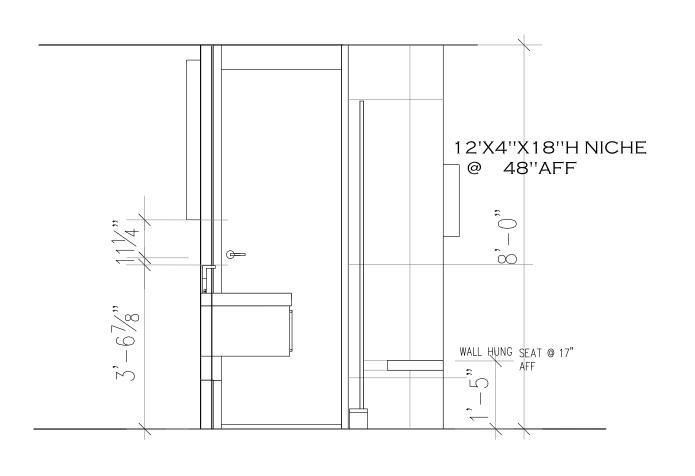

VIEW TO SHOWER SEAT/VANITY/DOOR


BATHROOM 2:

TOILET: WALL HUNG DURAVIT RIMLESS
HAPPY D.2 # 255009 WITH DARLING SEAT NEW
#006981
VANITY: DURAVIT VERO AIR #038255 WITH
CABINET T.B.S.

MED.
CABINET: 19"X39" RECESSED MEDICINE CAB. T.B.S.

FLOOR TILE: T.B.S.(25 SQ FT) SHOWER FLOOR TILE: T.B.S. (15 SQ FT) WALL TILE: T.B.S. (+/- 200 SQFT)

SHOWER SADDLE: MITEREED QUARTZITE TO MATCH TILE

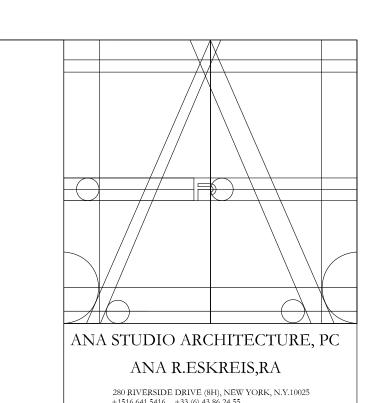

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NOTES

No.	Date	Description
1	1.17.2024	FIRST SUBMISSION(QUOTES)

TITLE

BATHROOM 2: FLOOR PLANS ELEVATIONS

SEAL & SIGNATURE

PROJECT No: 21007
DRAWN BY: JRS
CHECKED BY: ARE
DWG No:

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SPACE FOR NYC-BSCAN STICKER


Fine Line Engineers In

Electrical, Mechanical, Plumbing
Fire Protection, Construction Administrat
2089 W. 76TH STREET Hialeah, Fl. 330

Voice: 786.953-4901 - Fax: 786.953-4907
E-mail: cadinfo@flengineers.com

GEORGE FREIJO, P.E.

REGISTERED ENGINEER NO. 32578
STATE OF FLORIDA CA# 29796

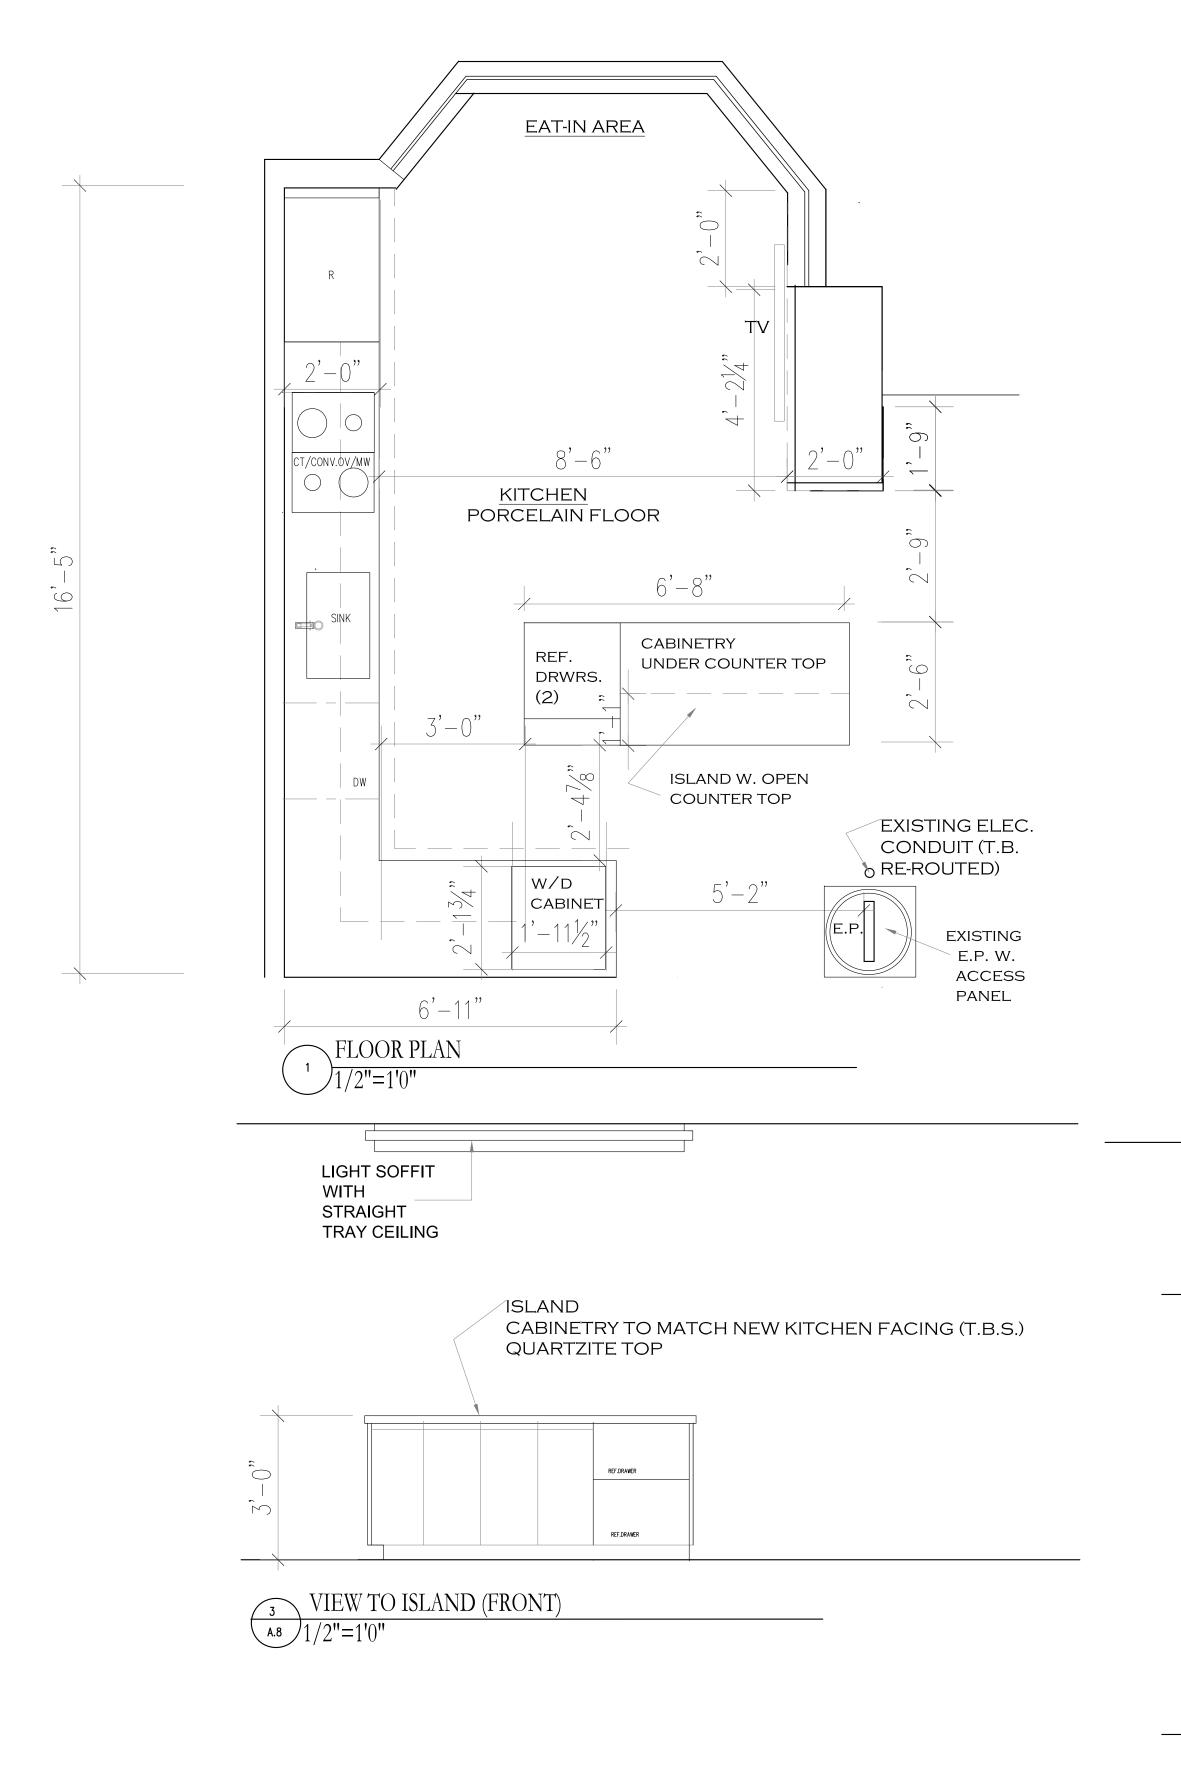




VIEW TO WASHER DRYER CABINET

A.8 1/2"=1'0"

LIGHT SOFFIT
WITH
STRAIGHT
TRAY CEILING

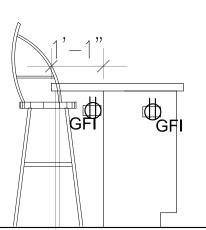

VIEW TO ISLAND (SIDE)

A.8 1/2"=1'0"

LIST OF APPLIANCES

MIELE COOKTOP: KM7730FR(30" INDUCTION top) OVEN: SHARP SMD2499FS (MW, CONVECTION, AIR FRIER, 110V)

HOOD: FABER HOOD INSERT, INHC29SSU
REFRIGERATOR:
SUBZERO 36" CLASSIC DOOR, PANEL RE ADY
CL 3650 UFDID/O (water dispenser inside unit)
ISLAND: (2) SUBZERO REF. DRAWERS, 24" PANEL
READY 1D-24r
SINK: FRANKE CUX 11027 (36" CAB) S/S
D.W.: ASKO ASEA DF1565, PANEL READY
W/D: ASKO ASEA W4114CW&T208VW, STACKED

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MIAMI BEACH, FL. 33139

NOTES

Date 1.17.2024	Description FIRST SUBMISSION(QUOTES)
1.17.2024	FIRST SUBMISSION(OLIOTES)
	1 1101 002111001011(2001110)

TITLE

KITCHEN: FLOOR PLANS ELEVATIONS

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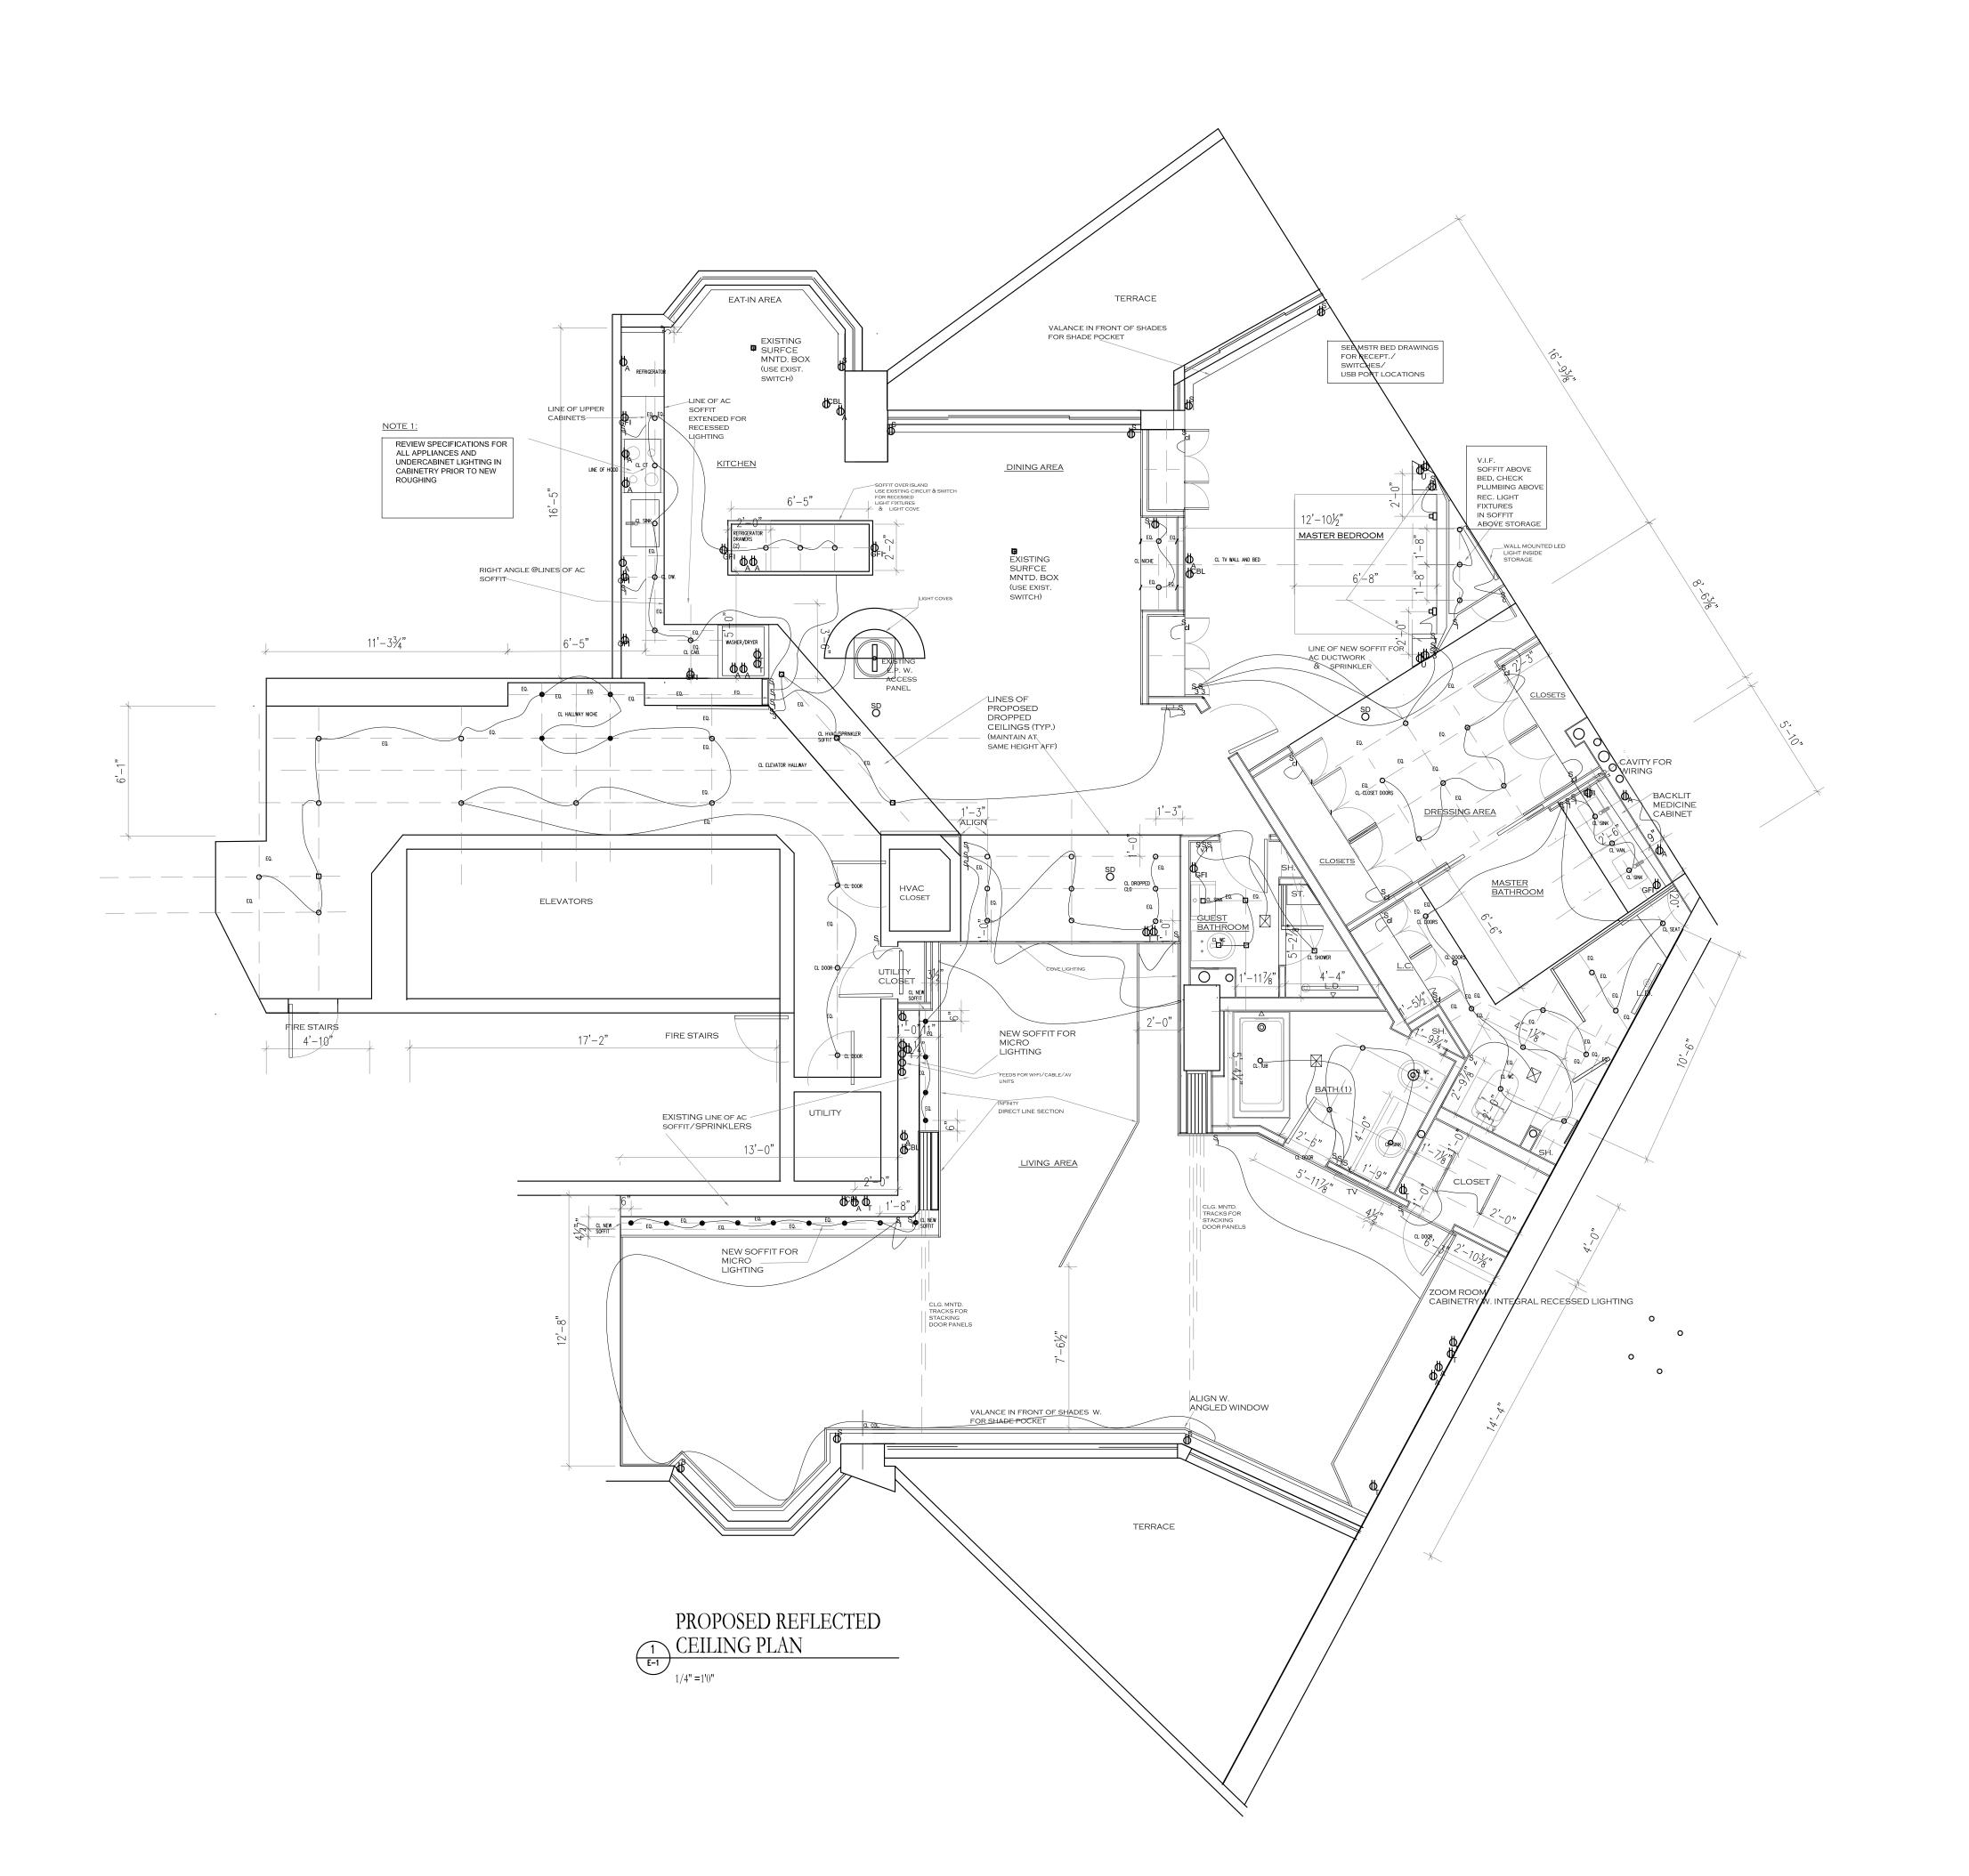
A-8

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GEORGE FREIJO, P.E.

REGISTERED ENGINEER NO. 32578
STATE OF FLORIDA CA#: 29796



LEGEND EXISTING "J" BOX FOR SURFACE MNTD. LIGHT FIXTURE (B.O.) 3" ROUND USAI BEVELED MINI COMPLETE W. INTEGRAL DRIVER B3RDL, TRIMLESS, CLASSIC WHITE SURFACE MOUNTED LED FLEXIBLE NECK READING LAMP ARTEMIDE "JET", LED, 1W (HARD WIRED) SURFACE MOUNTED LED SCONCE (TBS) @ 80"AFF 1.25" USAI LITTLEONES M1RD DOWNLIGHT, TRIMLESS, REMOTE DRIVER, 3000 K,WHITE WAC WS-236G2, 2700 K WAC WS-230GZ, 2700 K 36"L, WHITE LED, LOW VOLTAGE COVE & INFINITY TRACK LIGHTING FOR VINYL CEILING MEMBRANE ENOLIGHT HYN1204C REC. LINEAR TRIM W. CURVED FROSTED LENS ELECTRICAL DUPLEX OUTLET USB PORT ELECTRICAL FEED FOR LED TRANSFORMER ELECTRICAL APPLIANCE OUTLET ELECTRICAL GROUND FAULTED OUTLET CABLE OUTLET

ELECTRICAL FEED FOR SHADE CONTROL MOTOR SINGLE POLE SWITCH WITH 3-WAY LIGHT SWITCH WITH

> SMOKE DETECTORS(HARD-WIRED)(VIF) PROPOSED BATHROOM EXHAUST


CLOSET LOW VOLTAGE LED TUBE DOOR SWITCH LOW VOLTAGE TRANSFORMER FOR VINYL CEILINGS

<u>NOTE 1:</u> ALL OULETLOCATIONS TO MEET LOCAL CODES

REPLACE EXISTING
RECEPTACLES /SWITCHES TO
MATCH NEW
ALL WHITE DECORA SCREWLESS
WALL PLATES, DIMMERS T.B.S.
KITCHEN BACKSPLASH: SATIN s/s
SCREWLESS WALL PLATES

NOTE 2:

INVENTORY & REVIEW EXISTING
RECEPTACLES/GFCI'S FOR
CODE COMPLIANCE, ADD
AS NECESSARY, IN UNIT
AND ELEVATOR HALLWAY,
ALL FLOOR OUTLETS TO REMAIN

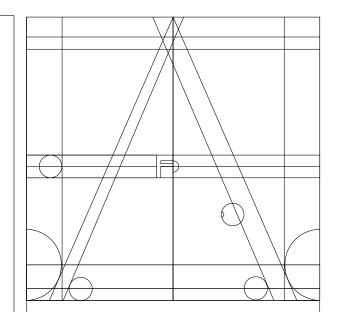

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WEXLER RESIDENCE 300 SOUTHPOINTE DR. 4304

MIAMI BEACH, FL. 33139

NOTES


No. Date Description 1.17.2024 FIRST SUBMISSION (QUOTES)

TITLE

REFLECTED CLG. PLAN


SEAL & SIGNATURE

PROJECT No: 21007 DRAWN BY: JRS
CHECKED BY: ARE

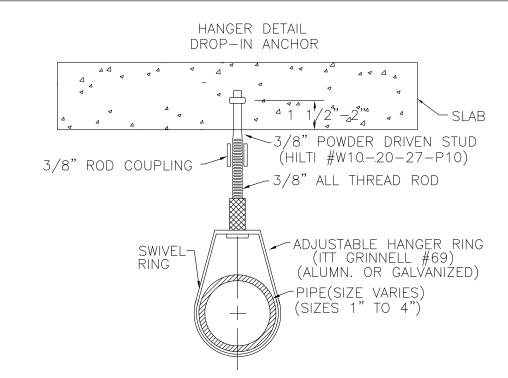

TYPICAL HANGER DETAIL

PIPE SIZE	ROD SIZE	TYPE OF FASTENER	MIN. 'C' DIM.	MAX. 'C' DIM.	
3/4"	3/8"	1-3/8" X 1-17/32" DROP-IN ANCHOR	1/2"	1-5/8"	
1"			5/8"	1-3/4"	
1-1/4"			13/16"	1-7/8"	
1-1/2"			15/16"	2"	
2"			1-3/16	2-3/8"	
2-1/2"	1/2"	1-1/2" X 2-1/32" DROP-IN ANCHOR	1-7/16"	2-3/4""	
3"			1-3/4"	3-1/4"	
3-1/2"			2"	3-5/8"	
4"	5/8"	1-5/8" X 2-15/32" DROP-IN ANCHOR	2-1/4"	3-7/8"	
5"			2-3/4"	4-3/4"	
6"	3/4"	1-3/4" X 3-1/4", DRPIN ANC.	3-5/16"	5-1/2"	
8"	N/A	N/A	N/A	N/A	

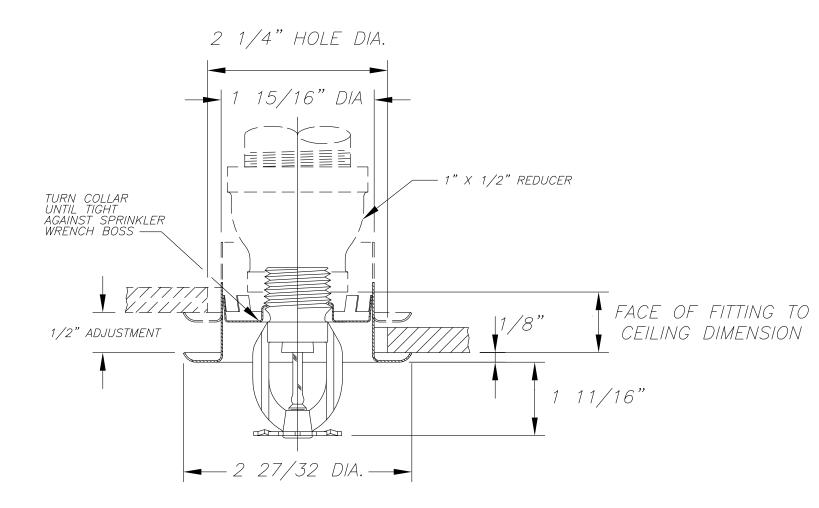


TYPICAL RECESSED PENDENT SPRINKLER DETAIL

FIRE PROTECTION NOTES:


- 1. ALL FIRE SPRINKLER WORK SHALL BE DONE ACCORDING TO LATEST N.F.P.A. 13, 25, 101 AND STATE AND LOCAL CODES AND ORDINANCES.
- 2. CONTRACTOR SHALL PAY ALL FEES, INSPEC-TION AND CONNECTION CHARGES REQUIRED.
- 3. SPRINKLER CONTRACTOR SHALL VERIFY ALL SPACE CONDITIONS AND DIMENSIONS AT JOB SITE PRIOR TO FABRICATION AND INSTALL-ATION OF MATERIALS AND EQUIPMENT.
- 4. COORDINATE WORK WITH OTHER TRADES.
- 5. SUBMIT SHOP DRAWINGS TO ENGINEER FOR APPROVAL OF ALL EQUIPMENT, MATERIALS, LAYOUTS AND CALCULATIONS, PRIOR TO INSTALLATION.
- 6. SPRINKLER CONTRACTOR SHALL GUARANTEE ALL WORK FREE OF DEFECTS IN MATERIAL AND WORKMANSHIP FOR A PERIOD OF ONE YEAR FROM DATE OF ACCEPTANCE.
- 7. FIRE LINES [INCLUDING FIRE SPRINKLER
- 1. <u>underground</u>: ductile iron pipe.
- 2. <u>ABOVE GROUND</u>: SCHEDULE 10 ALLIED XL-IN CONCEALED
- 3. SPRINKLER STANDPIPE SHALL BE SCHEDULE 10 BLACK STEEL PIPE WITH GROOVED FITTINGS.
- NOTE: ALL PIPING SHALL BE TREATED WITH M.I.C. PROTECTION
- 8. ALL VALVES SHALL BE UL LISTED FOR FIRE PROTECTION SERVICE AND BE SUPERVISED BY THE FIRE ALARM SYSTEM.




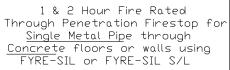

CAJ1142

Drawing not to scale F-rating = 1 & 2 Hr. T-rating = 0 Hr.

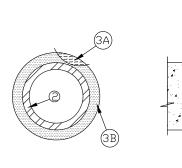

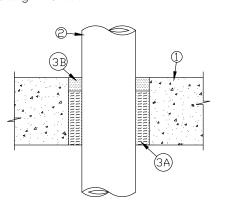

Floor or Wall assembly = $4\frac{1}{2}$ " thick concrete ②·Steel Pipe - 4" diam.(or smaller) Sch. 40 (or heavier) steel. ·Annular space is max. 3/,4" (S) A) 3½ " thick mineral wool (min 4.0 pcf), friction fitted.

B) 1" thickness of FYRE-\$IL or FYRE-\$IL \$/L (floors only)

FIRE RATED PIPE PENETRATION DETAIL

9. DOUBLE CLAPPER PROJETING SIAMESE CONNECTIONS SHALL BE GUARDIAN MODEL 133 OR EQUAL.

10. <u>TESTS:</u>

WATER PIPING: TEST TO 50 PSI BEYOND THE HIGHEST ANTICIPATED PRESSURE.


ALL LOW POINTS TO BE EQUIPPED WITH AUXILIARY DRAINS PER NFPA 13

- 11. ALL EXPOSED WET PIPING SHALL BE INSULATED TO PREVENT FREEZING
- 12. THESE DRAWINGS WERE PREPARED BASED ON NFPA-13, 2002 EDITION
- 13. CONTRACTOR SHALL PROVIDE SHOP DRAWINGS. SHOP DRAWINGS SHALL COMPLY WITH N.F.P.A 13 AND NFPA 101.8.6.7 THESE DRAWINGS ARE A BASIS OF DESIGN ONLY. CONTRACTOR SHALL INCLUDE ANY MISSING INFORMATION BASED ON N.F.P.A. 13.
- 14. SEE FIRE ALARM DRAWINGS FOR ALL SEQUENCES AND INTERLOCK BETWEEN FIRE SPRINKLER SYSTEM AND FIRE ALARM SYSTEM.
- 15. ELEVATORS SHALL BE PROTECTED PER NFPA 13.4-5.5. UNIFORME SAFETY RULES, CHAPTER 4A-47. COMPLIANCE WITH STATE FIRE MARSHALS RULES 4A-47.


OCCUPANCY AND HAZARD CLASSIFICATION SCHEDULE

	<u>OCCUPANCY</u>	HAZARD CLASSIFICATION	AREA S.F.	COVERAGE	SPACING	DENSITY
	RESIDENTIAL LIGHT HAZARD		1899 144 S.		12'x12'	0.15 GPM S.F.
NOTE: FOR OCCUPANCY LOAD SEE SHEET LIFE SAFETY DRAWINGS						

1 or 2 Hour Fire Rated Through Penetration Firestop for Single

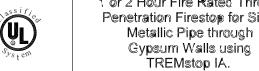




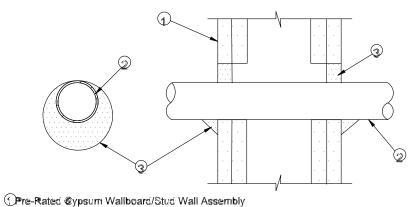

Metallic Pipe - A) Steel Pipe - 12" diam. (or smaller) Sch. 10 (or heavier) steel pipe. B) Iron Pipe - 12" diam. (or smaller) cast or ductile iron pipe. C) Copper Tubing - 4" diam. (or smaller) Type L (or heavier) copper tubing. D) Copper Pipe - 4" diam. (or smaller) Regular (or heavier) copper pipe. The annular space shall be min. 0" to max. 1" within the firestop system. 3TREMstop IA - Min. 1/2" thickness of sealant applied within opening. Min. 1/4"


cant bead of sealant to be applied at point contact.


FIRE RATED PIPE PENETRATION DETAIL

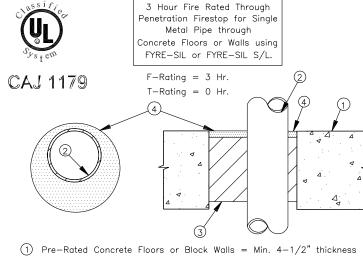


2 Metallic Pipe: A) Steel Pipe — 8" diam. (or smaller) Sch. 10 (or heavier) steel pipe. B) Conduit — 4" diam. (or smaller) EMT or steel conduit C) Copper Tubing — 4" diam. (or smaller) Type L (or heavier) copper tubing. D) Copper Pipe - 4" diam. (or smaller) Regular (or heavier) copper pipe. The annular space shall be min. 1/2" to max. 3-3/8" within the firestop system. \bigcirc Packing Material — Min. 3—1/2" thick mineral wool (min. 6.0 pcf) insulation, firmly packed into opening as a permanent form. (4) FYRE-SIL or FYRE-SIL S/L - Min. 1/2" thickness of sealant applied within annulus, flush with top of floor surface or with both sides of the wall assembly.


NOTE: Apply FYRE-SIL S/L to Floor Applications Only. FIRE RATED PIPE PENETRATION DETAIL

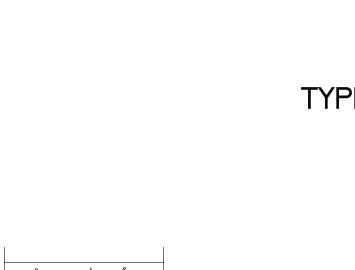


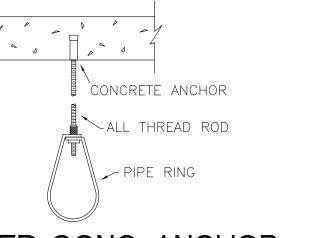



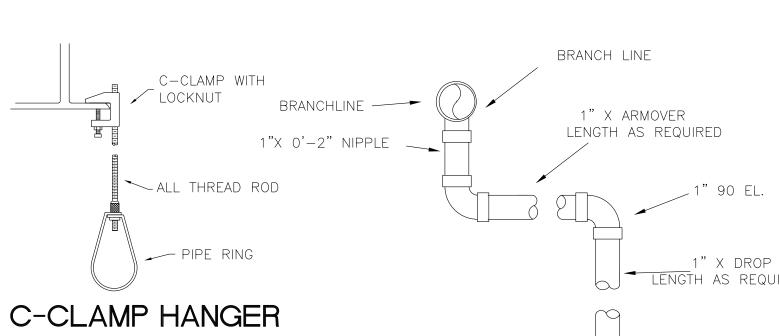

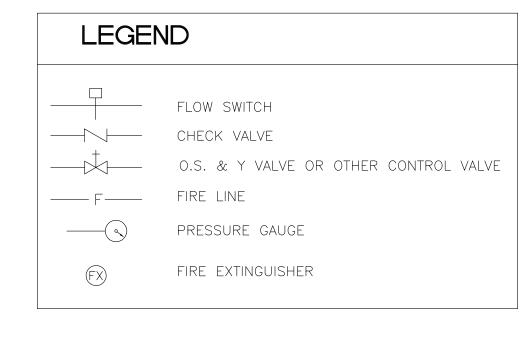

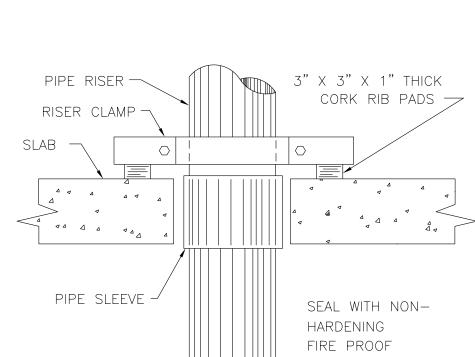


TYPICAL VERTICAL WATER PIPE SUPPORT DETAILS


MASTIC AROUND


PIPE SLAB

OPENING

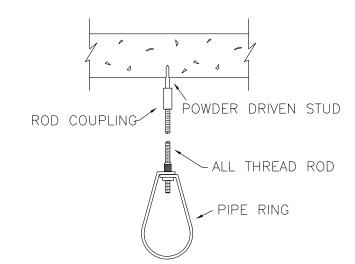

POWDER DRIVEN STUD HANGER

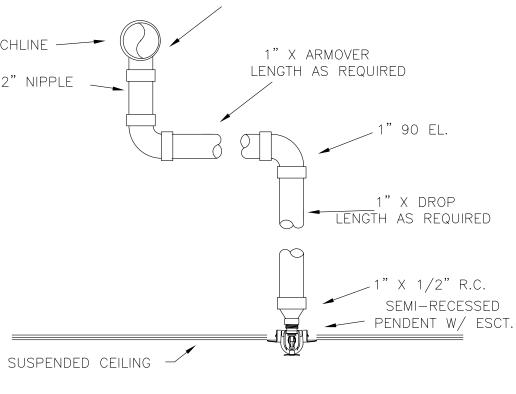

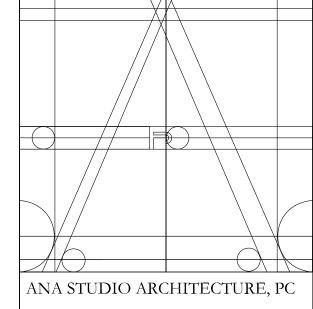

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WEXLER RESIDENCE 300 SOUTHPOINTE DR 4304

MIAMI BEACH, FL. 33139

NOTES

1.17.2024 FIRST SUBMISSION


TITLE

FIRE PROTECTION

SEAL & SIGNATURE DATE: 1.17.2024 PROJECT No: 21007 DRAWN BY: JRS CHECKED BY: ARE

PAGE100F12

TYP. SWING AND DROP ASSEMBLY

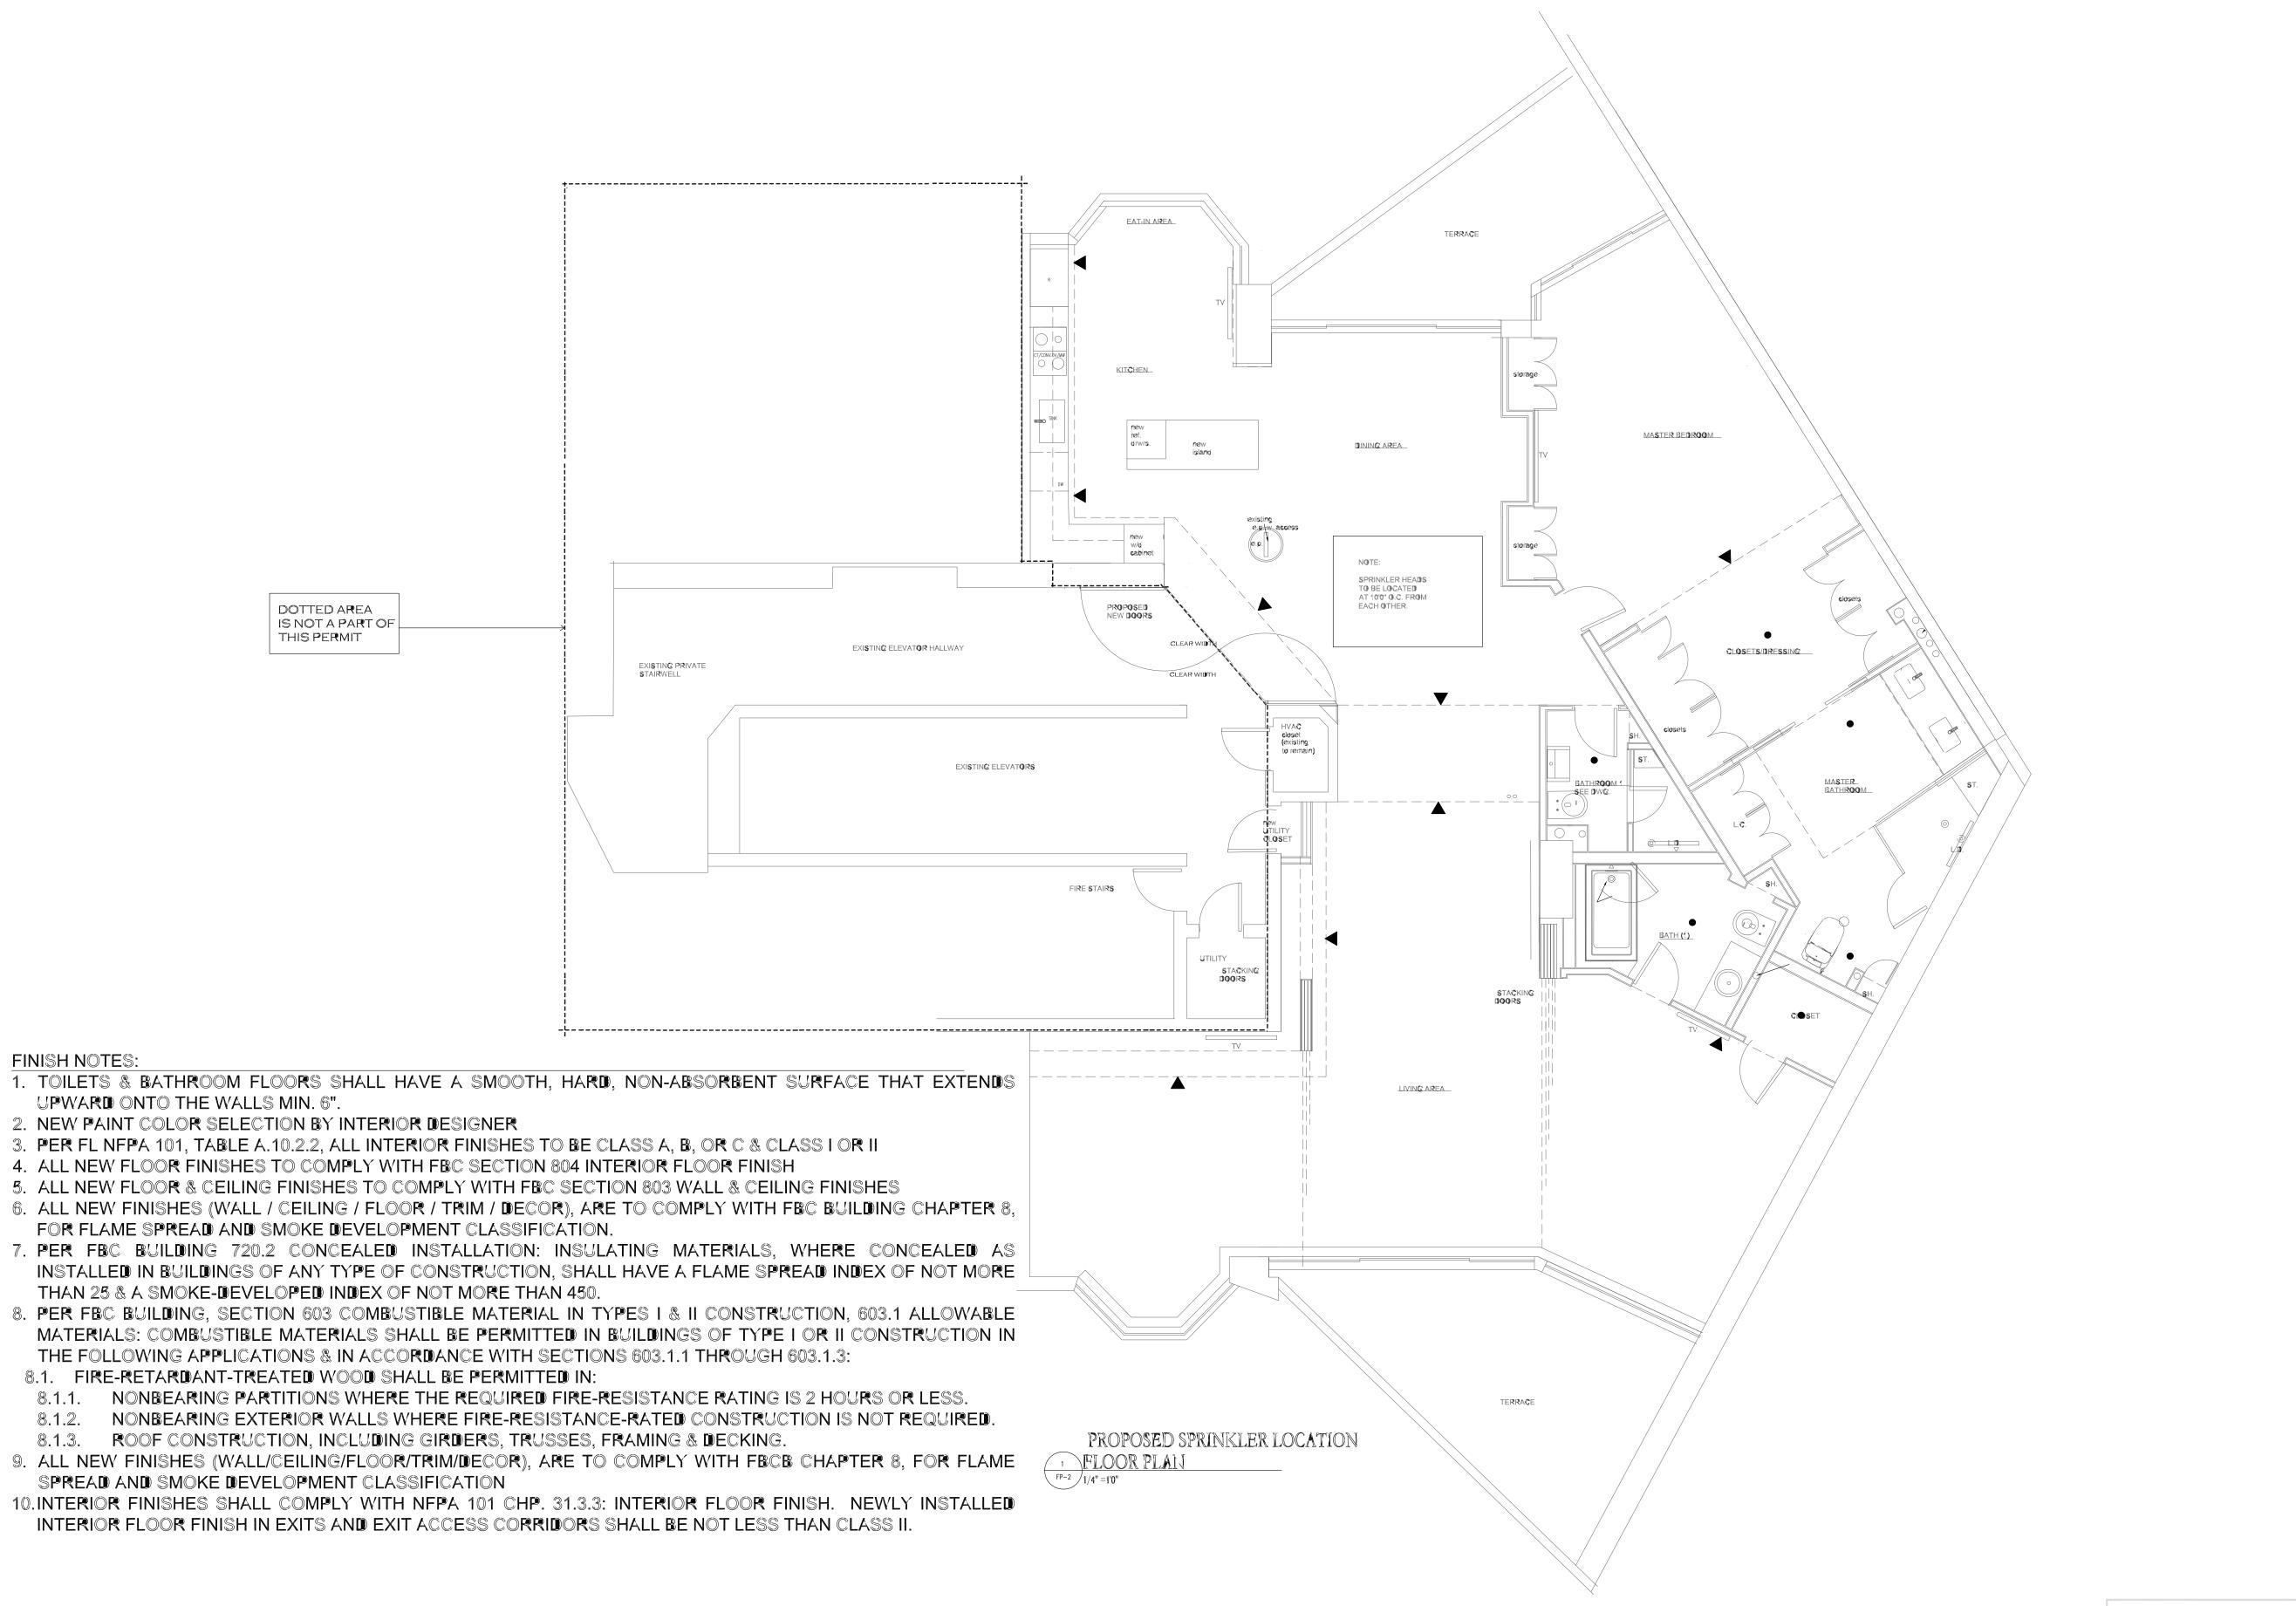

FINISH NOTES:

Fine Line Engineers Inc

CHECKED BY: ARE

FP-2

ANA STUDIO ARCHITECTURE, PC

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WEXLER RESIDENCE

300 SOUTHPOINTE DR.

MIAMI BEACH, FL.

NOTES

TITLE

FIRE SPRINKLER

LOCATIONS

LIFE SAFETY SCOPE OF WORK:
RELOCATE FIRE ALARMS. FIRE ALARM
SUBCONTRACTOR TO SUBMIT SHOP DRAWINGS
UNDER SEPARATE PERMIT FOR CMB REVIEW
AND APPROVAL

RELOCATE FIRE SPRINKLERS. FIRE SPRINKLER SUBCONTRACTORTO SUBMIT SHOP DRAWINGS UNDER SEPARATE PERMIT FOR CMB REVIEW AND APPROVAL.

IN CONFORMANCE WITH NFPA1, CHAPTER 4.5.6:
DEMOLITION AND CONSTRUCTION SHALL NOT
LIMIT OR DEGRADE ANY EXISTING LIFE SAFETY
FEATURES OF THE EXISTING FACILITY,
INCLUDING BUT NOT LIMITED TO, EMERGENCY
EGRESS, EMERGENCY POWER, EMERGENCY
LIGHTING, FIRE ALARM OR FIRE SPRINKLER
FUNCTION. ANY TEMPORARY SHUT DOWN OF
ANY SYSTEMS SHALL BE COORDINATED WITH
FIRE DEPARTMENT INSPECTION PERSONNEL,
IN ADVANCE OF PERFORMING WORK AT THE
CONSTRUCTION SITE


FIRE PROTECTION NOTES:

- 1. THE FIRE PROTECTION SYSTEM INSTALLATION AND MATERIALS SHALL BE IN COMPLIANCE WITH THE APPLICABLE BUILDING CODES AND FLORIDA FIRE PREVENTION CODE, AND NFPA 101.
- 2. SPRINKLER SYSTEM TO BE INSTALLED BE A STATE-CERTIFIED FIRE PROTECTION CONTRACTOR. CONTRACTOR SHALL PROVIDE FIRE SPRINKLER SHOP DRAWINGS FOR REVIEW BY THE FIRE DEPT. ALSO, CONTRACTOR SHALL PROVIDE HYDRAULIC CALCULATIONS USING A FLOW TEST OF NO OLDER THAN 6 MONTHS, IF REQUIRED BY THE FIRE DEPARTMENT. SUBMIT ALL SHOP DRAWINGS AND CALCULATIONS TO ARCHITECT OR ENGINEER FOR REVIEW PRIOR TO STARTING WORK.
- 3. CONTRACTOR SHALL COORDINATE WITH STRUCTURE, CEILING GRID, AND ELEVATIONS, AND OTHER HVAC AND ELECTRICAL DISCIPLINES BEFORE FABRICATING AND INSTALLING SPRINKLER PIPING. MAKE OFFSETS IN PIPING AS REQUIRED PER FIELD CONDITIONS. MAINTAIN 6" CLEARANCE BETWEEN PIPING AND 1- AND 2-HOUR RATED WALLS.
- 4. ALL VALVES SHALL BE OF DOMESTIC MANUFACTURER, U.L. LISTED FOR FIRE PROTECTION SERVICE AND RATED FOR 175PSI WORKING PRESSURE. PROVIDE U.L. LISTED / FM APPROVED TAMPER SWITCHES, WHERE SHOWN AT CONTROL VALVE LOCATIONS.
- 5. SPRINKLER HEADS SHALL BE U.L. LISTED AND EQUIVALENT TO TYCO RF-2 5.6K, 155 DEGREE QUICK RESPONSE RECESSED TYPE AND RATED FOR 175PSI WORKING PRESSURE. CONTRACTOR SHALL PROVIDE AND TURN OVER TO THE OWNER AT LEAST SIX SPARE SPRINKLER HEADS AND COVERS OF EACH TYPE AND TEMPERATURE RATING BEING INSTALLED.

= PENDENT HEAD

■ = SIDEWALL HEAD

- 6. CONTRACTOR SHALL PROVIDE FLUSHING CONNECTIONS WHERE SHOWN ON PLANS. PROVIDE A DRAIN CONNECTION FOR ALL TRAPPED SECTION OF PIPING.
- 7. ABOVE-GROUND PIPING SHALL BE EITHER:
- 7.1. BLAZEMASTER CPVC PIPE U.L. LISTED 1" THROUGH 3".
- 7.2. CAST IRON TO MATCH EXISTING ON SITE
- 7.3. GALVANIZED STEEL
- 8. RISERS SHALL BE SCHEDULE 10BLACK STEEL PIPE, PER JOB CONDITIONS AND INSTALL PIPING TIGHT TO STRUCTURE POSSIBLE.
- 9. PRESSURE TEST ABOVE-GROUND PIPING HYDROSTATICALLY AT 200PSI FOR 2 HOURS IN ACCORDANCE WITH NFPA-13. FLUSH OUT ALL PIPING IN ACCORDANCE WITH NFPA-13. PROVIDE TYPED AND COMPLETED NFPA-13 TEST CERTIFICATE FOR ABOVE-GROUND PIPING.
- 10. SPRINKLER HEADS SHALL MATCH EXISTING, UNLESS OTHERWISE NOTED ON PLANS.
- 11. SPRINKLER HEADS SHALL BE LOCATED NO LESS THAN 12" FROM THE EXTERIOR EDGE OF ELECTRICAL FIXTURES, INCLUDING LIGHT FIXTURES, SMOKE DETECTORS, J-BOXES, ETC. SUBCONTRACTOR TO COORDINATE INSTALLATION OF EACH HEAD WITH OTHER TRADES, AND NOTIFY ARCHITECT IN WRITING IN CASE OF ANY DISCREPANCIES BETWEEN PLANS AND SITE CONDITIONS.
- 12. SIDEWALL SPRINKLER HEADS SHALL HAVE MINIMUM 6" CLEARANCE FROM ANY STRUCTURE, TRIM, MILLWORK, ETC. OVERHEAD OR LATERAL.
- 13. ALL SPRINKLER HEADS TO BE RECESSED. SPRINKLER CONTRACTOR TO PROVIDE CAPS AT ALL SPRINKLER HEADS
- 14. SHOULD THE FIRE SPRINKLER SYSTEM BE DISCONNECTED FOR MORE THAN 4 HOURS, GENERAL CONTRACTOR SHALL ESTABLISH A FIRE WATCH UNTIL THE SYSTEM IS FULLY OPERATIONAL.

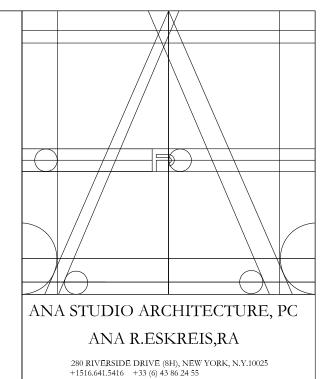

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MIAMI BEACH, FL.

NOTES

4304

No. Date Description

1.17.2024 FIRST SUBMISSION(QUOTES)

TITLE

LIFE SAFETY

SEAL & SIGNATURE

PROJECT No: 21007

DRAWN BY: JRS

CHECKED BY: ARE

DWG No:

LS-1

LS-1

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